
ETHELDORE APARTMENTS

MOSS BEACH, CA PUD 121





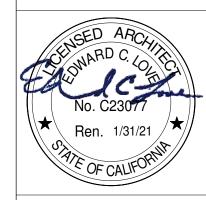

DATE: 4/18/202

DRAWN: ECL

JOB:ETHELDORE APTS
SHEET:

SITE DATA:

APN: 037-097-200 ZONING: PUD-121/DR/CD OCCUPANCY GROUP:R-2 TYPE OF CONSTRUCTION: V-B

PRE: PLN: 2019-00143 BLD:

Owner:

APPLICABLE CODES: SAN MATEO COUNTY ZONING & BUILDING ORDINANCES

2019 CALIFORNIA BUILDING CODE
2019 CALIFORNIA MECHANICAL CODE
2019 CALIFORNIA PLUMBING CODE
2019 CALIFORNIA ELECTRICAL CODE
2019 CALIFORNIA ENERGY CODE
2019 CALIFORNIA FIRE CODE
2019 CALIFORNIA GREEN BUILDING STANDARDS CODE

Gıpson Purayampallıl

Moss Beach CA 94038 ჟเpsonpj@yahoo.*co*m 408.234.9335

Half Moon Bay, CA 94019 edwardclovearch@gmail.com 650.728.7615

POBox 3201

Architect: Edward C Love, Architect 720 Mill St

Civil Sigma Prime Geosciences, Inc Engineering \$\pm\$: 332 Princeton Ave Geotech Half Moon Bay, CA 94019 sigmaprm@gmail.com 650.728.3590

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	EXISTING	EXISTING PROPOSED TOTAL			ALLOWED				
	AREA (SQFT)	%	AREA (SQFT)	%	AREA (SQ	FT)	%	AREA (SQFT)	%
LOT AREA	2085								
LOT COVERAGE	3550	17.0	698.	3 33.5		10533	50.5	C	0.0
FLOOR AREA	Commercial Space 3550		Bldg Unit	3 3 5 0 3	Commercial Space Bldg Unit Bldg Unit 2 Bldg Unit 3 Bldg Unit 4 Bldg 2 Unit Bldg 2 Unit 2 Bldg 2 Unit 3	3550 1345 1328 1328 1345 1230 1178 1177			
	Total 3550	17.0	Total 1016	48.7	Blag 2 Unit 4 Total	1 230 13711	65.8	Total O	0.0

ON SITE PARKING SUMMARY:

COMMERCIAL: COMMERCIAL & GUEST PARKING: RESIDENTIAL PARKING: ADA PARKING: TOTAL SPACES: 30 (PROVIDED)


SCOPE OF WORK:

CONSTRUCTION OF (2) FOUR UNIT APARTMENT BUILDINGS OVER PARKING

NOTES:

I. EXTERIOR LIGHTING WILL BE RECESSED DOWN LIGHTS IN SOFFITS

Sheet List - DD				
Sheet				
Number	Sheet Name			
A000	Title Sheet			
A00 I	Cover Sheet			
SU	Survey			
A003	Site Plan - Existing			
A004	Site Plan - Level I			
A005	Site Plan - Level 2 - Bldg \$ 2			
A006	Site Plan - Level 3 - Bldg \$ 2			
A007	Site Plan - Level 4 - Bldg \$ 2			
C-1	Drainage & Grading			
C-2	Erosion Control Plan			
C-3	Details			
C-4	Best Management Practices			
AIOI	Floor Plans Building 1			
A102	Floor Plans Building 2			
A103	Roof Plan - Bldg \$ 2			
A104	Area Plan			
A201	Elevations - Bldg East & West			
A202	Elevations - Bldg 2 East \$ West			
A203	Elevations - South			
A204	Elevations - South Site			
A205	Elevations - North			
A206	Renders			
A503	Section - Driveway Entrances			
A504	Section - Thru Site			
A505	Section - Bldg 2			
CB0 I	Color Board 1			
LP	Landscape Plan			
DoS1	Demostration of Scale			

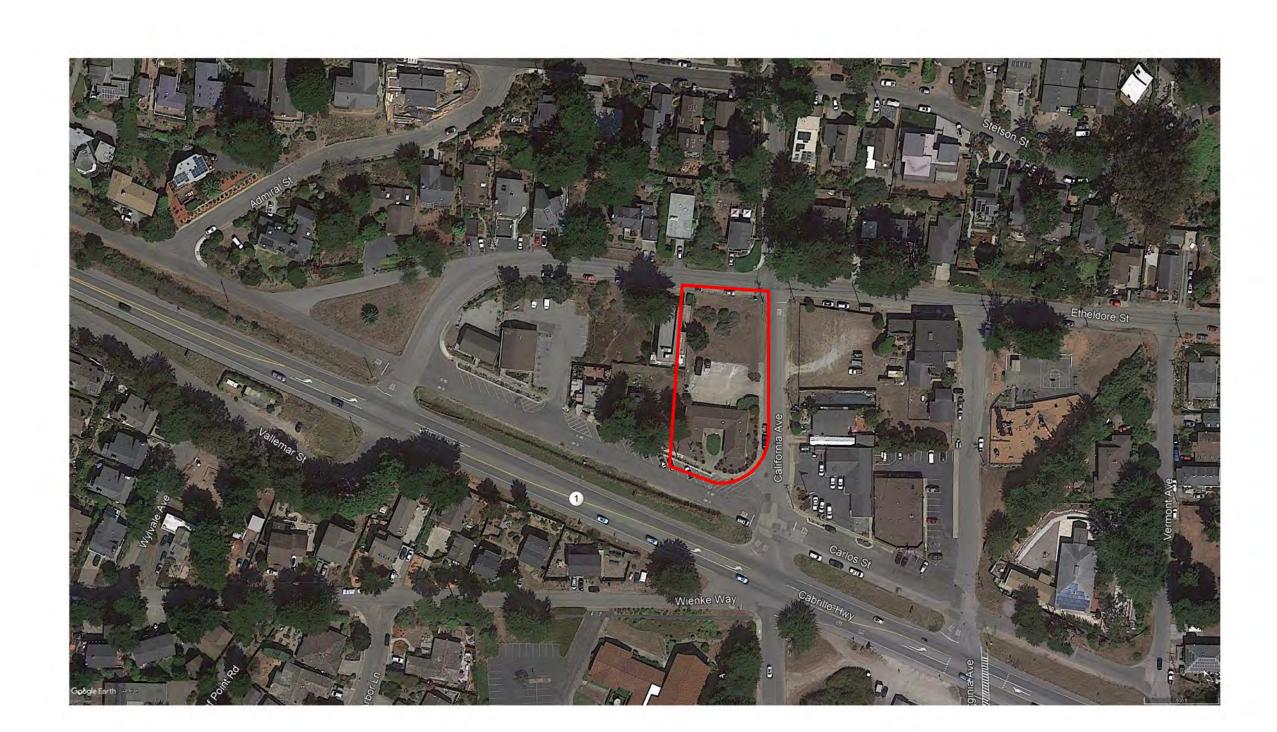





REVISIONS



Apartments

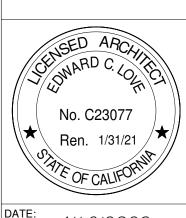

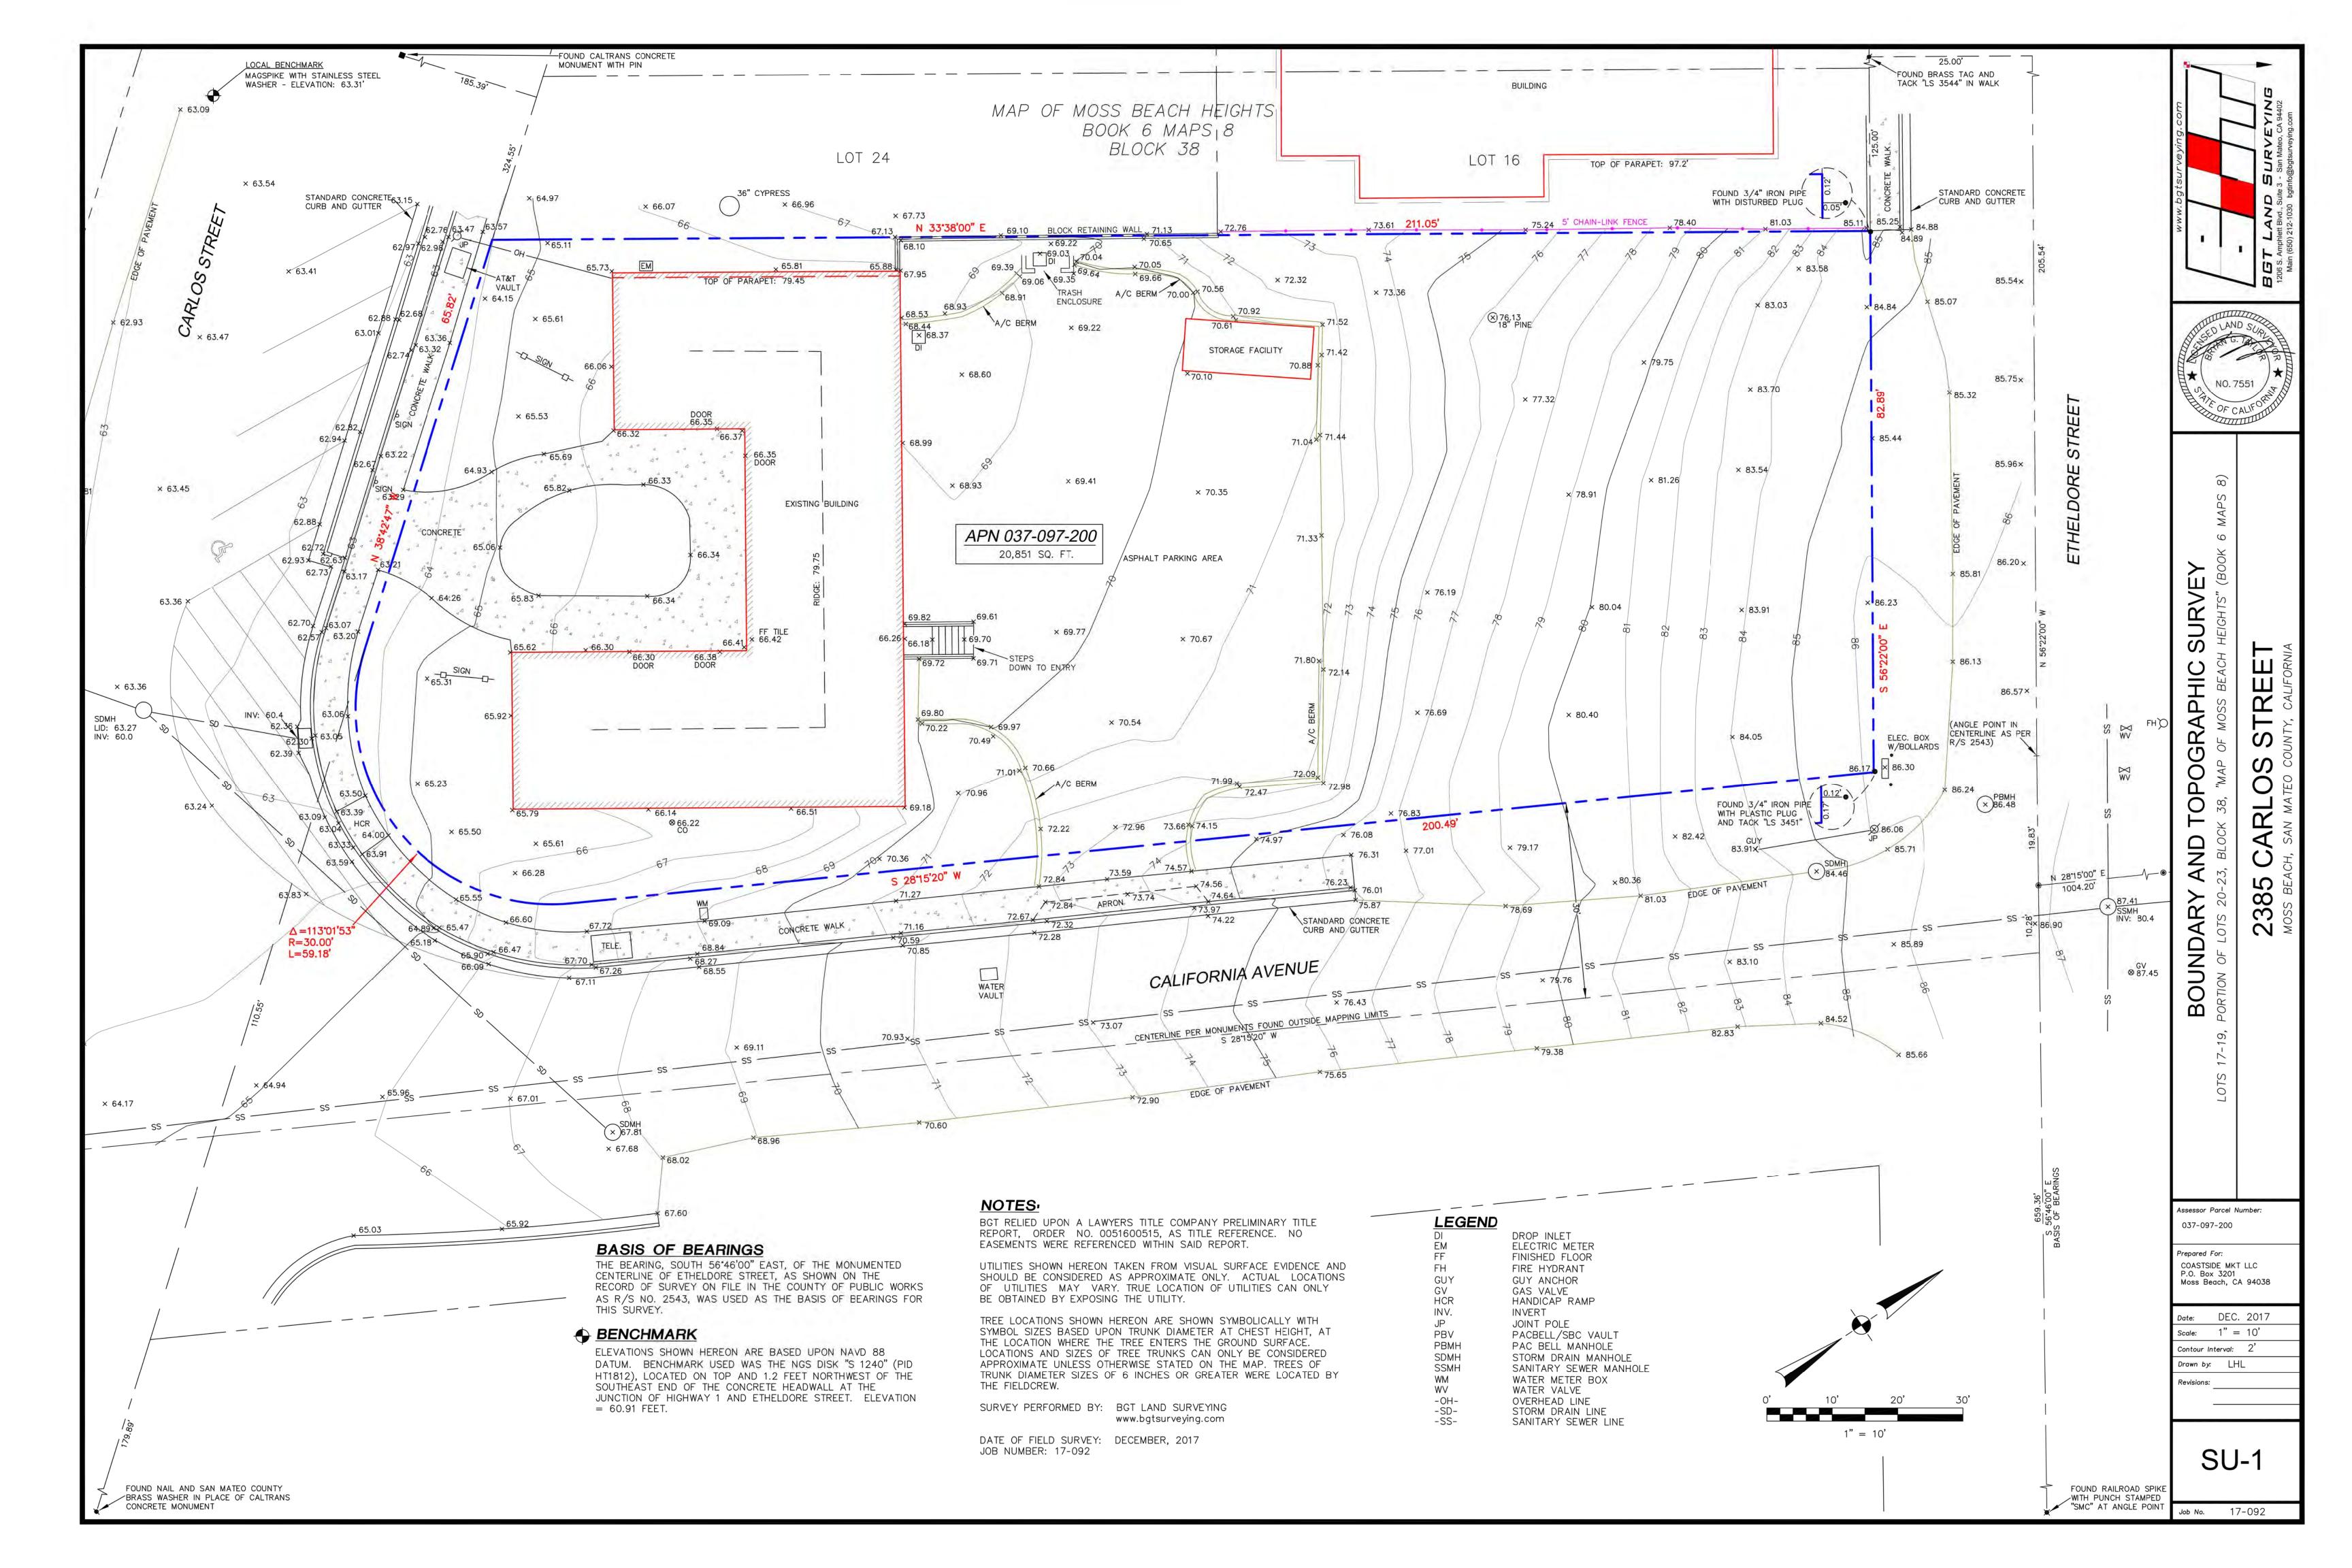

JOB: ETHELDORE APTS

SHEET:


EXISTING TELEPHONE BUILDING MAP OF MOSS BEACH HEIGHTS BOOK 6 MAPS 8 BLOCK 38 LOT 24 EXISTING COMMERCIAL BUILDING APN 037-097-200 20,851 SQ. FT. I STORY, 3550 SQFT


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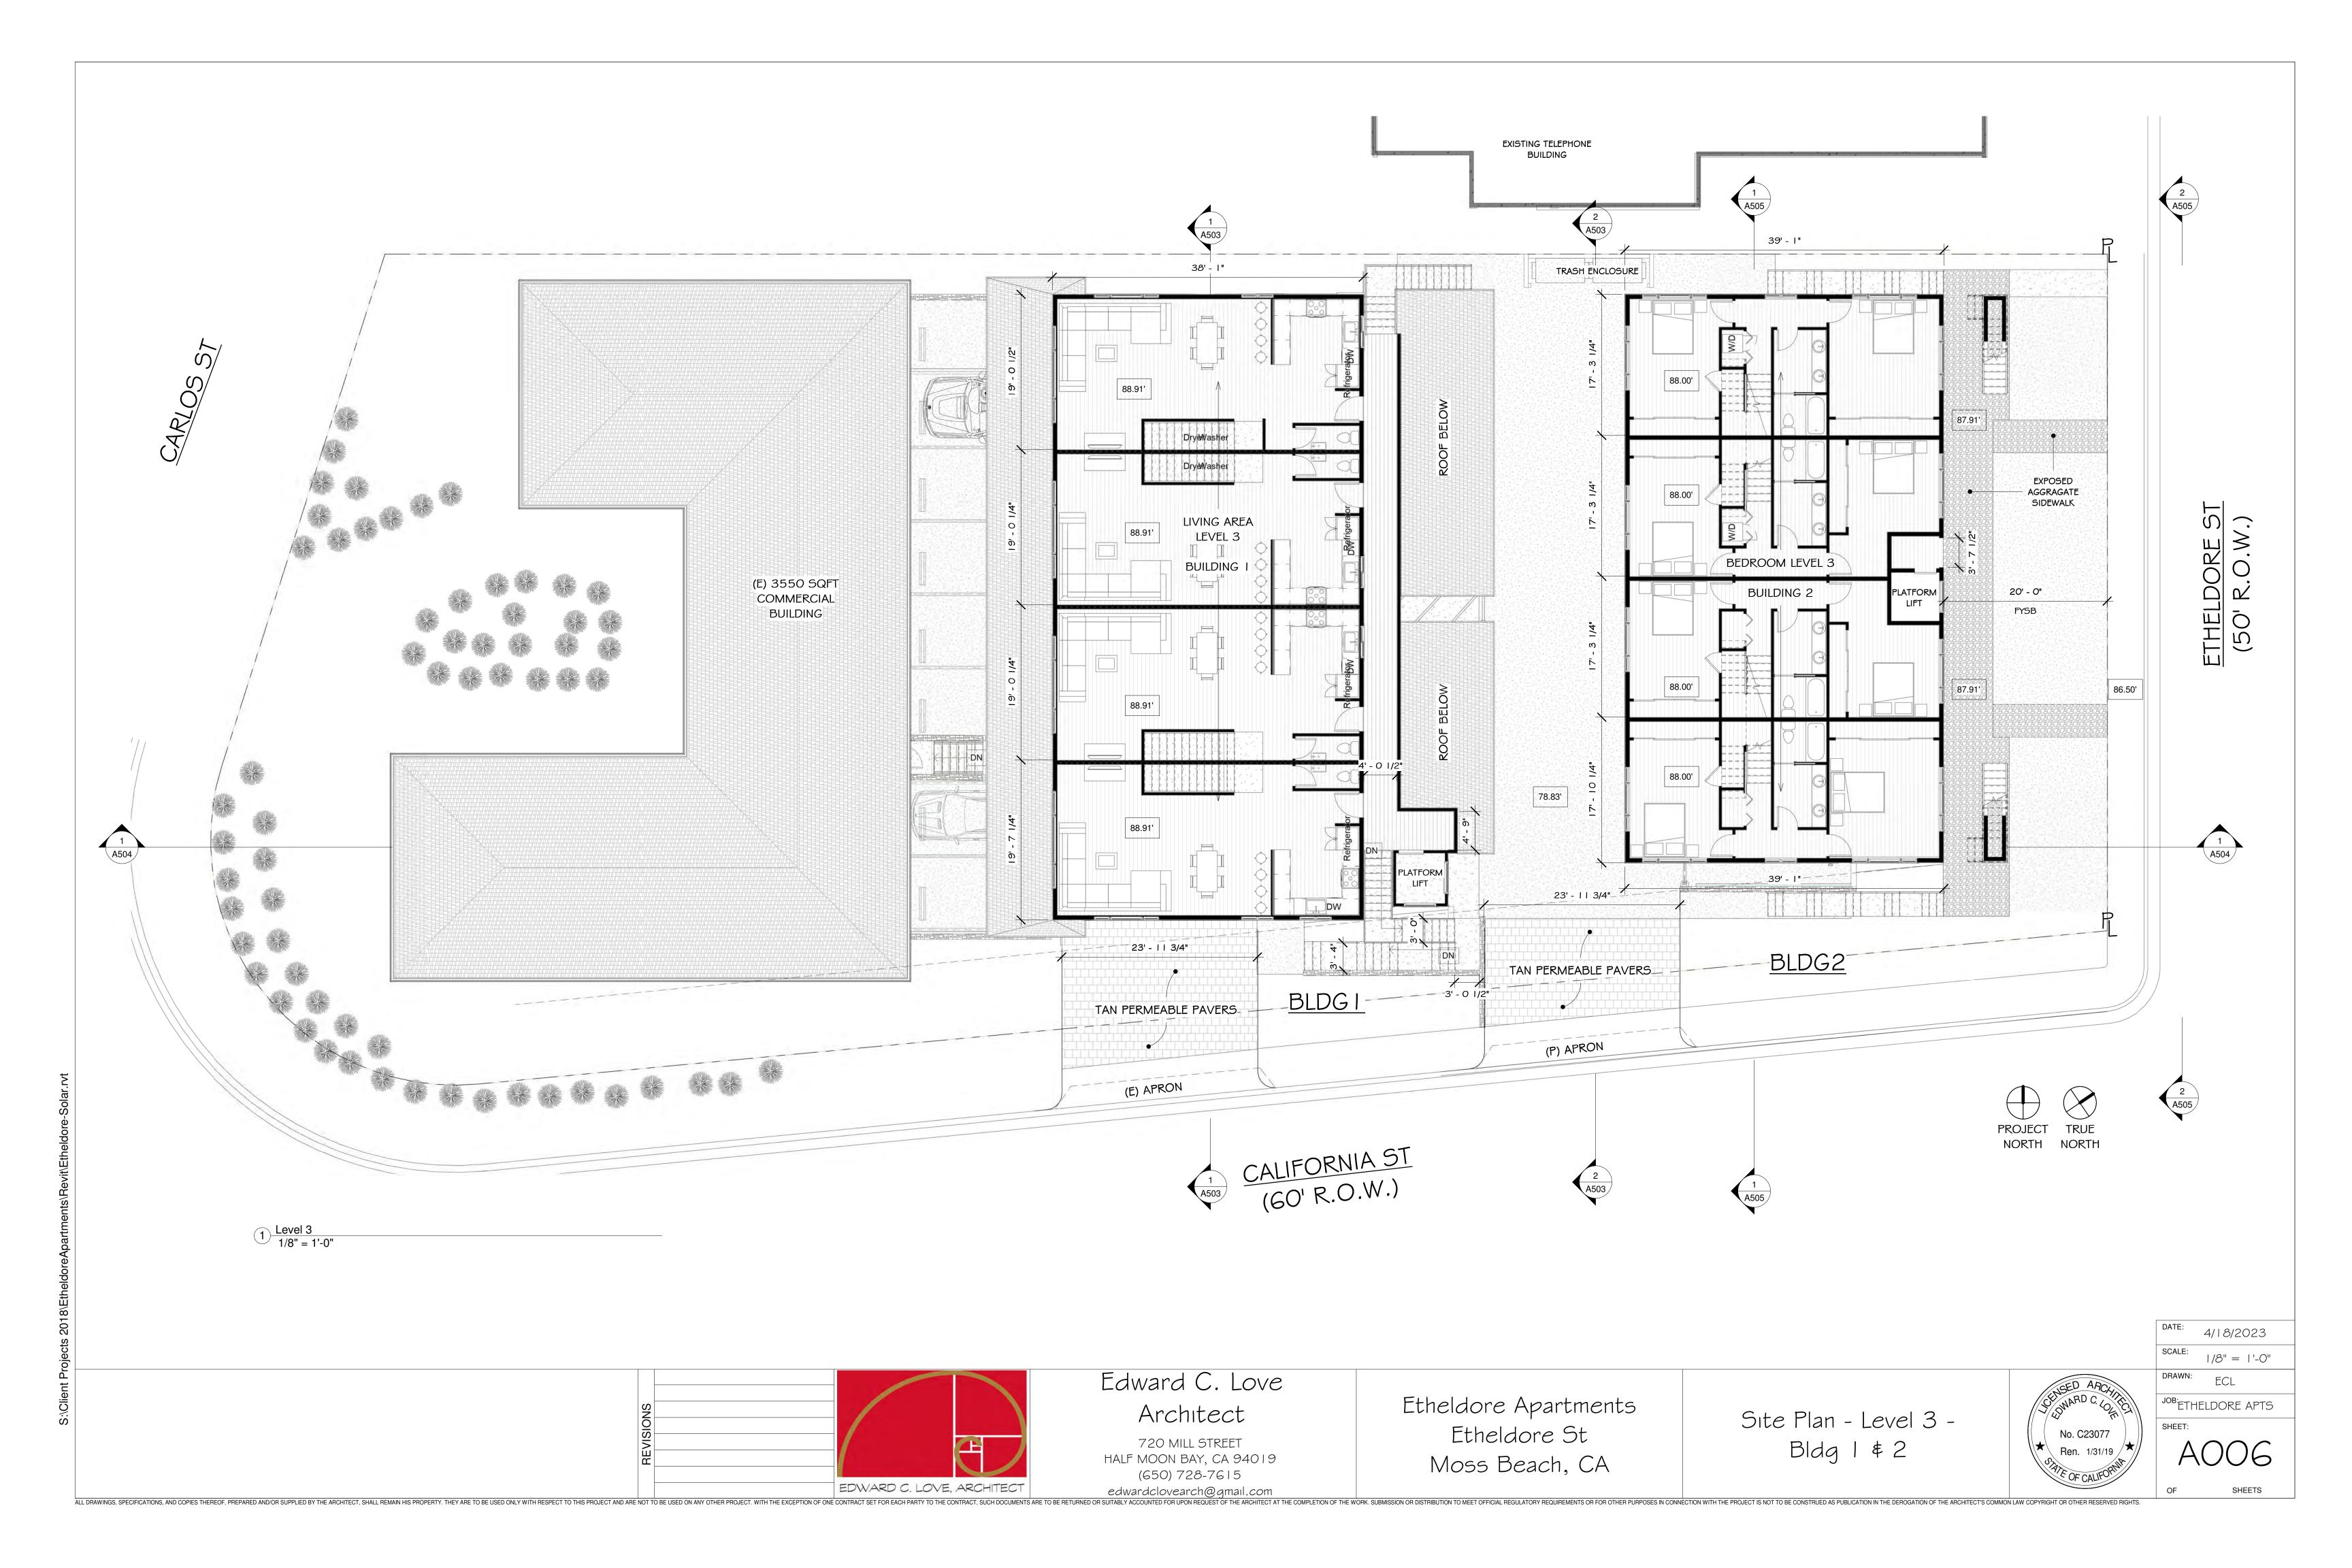
 $1 \frac{\text{Site Plan}}{1/16"} = 1'$


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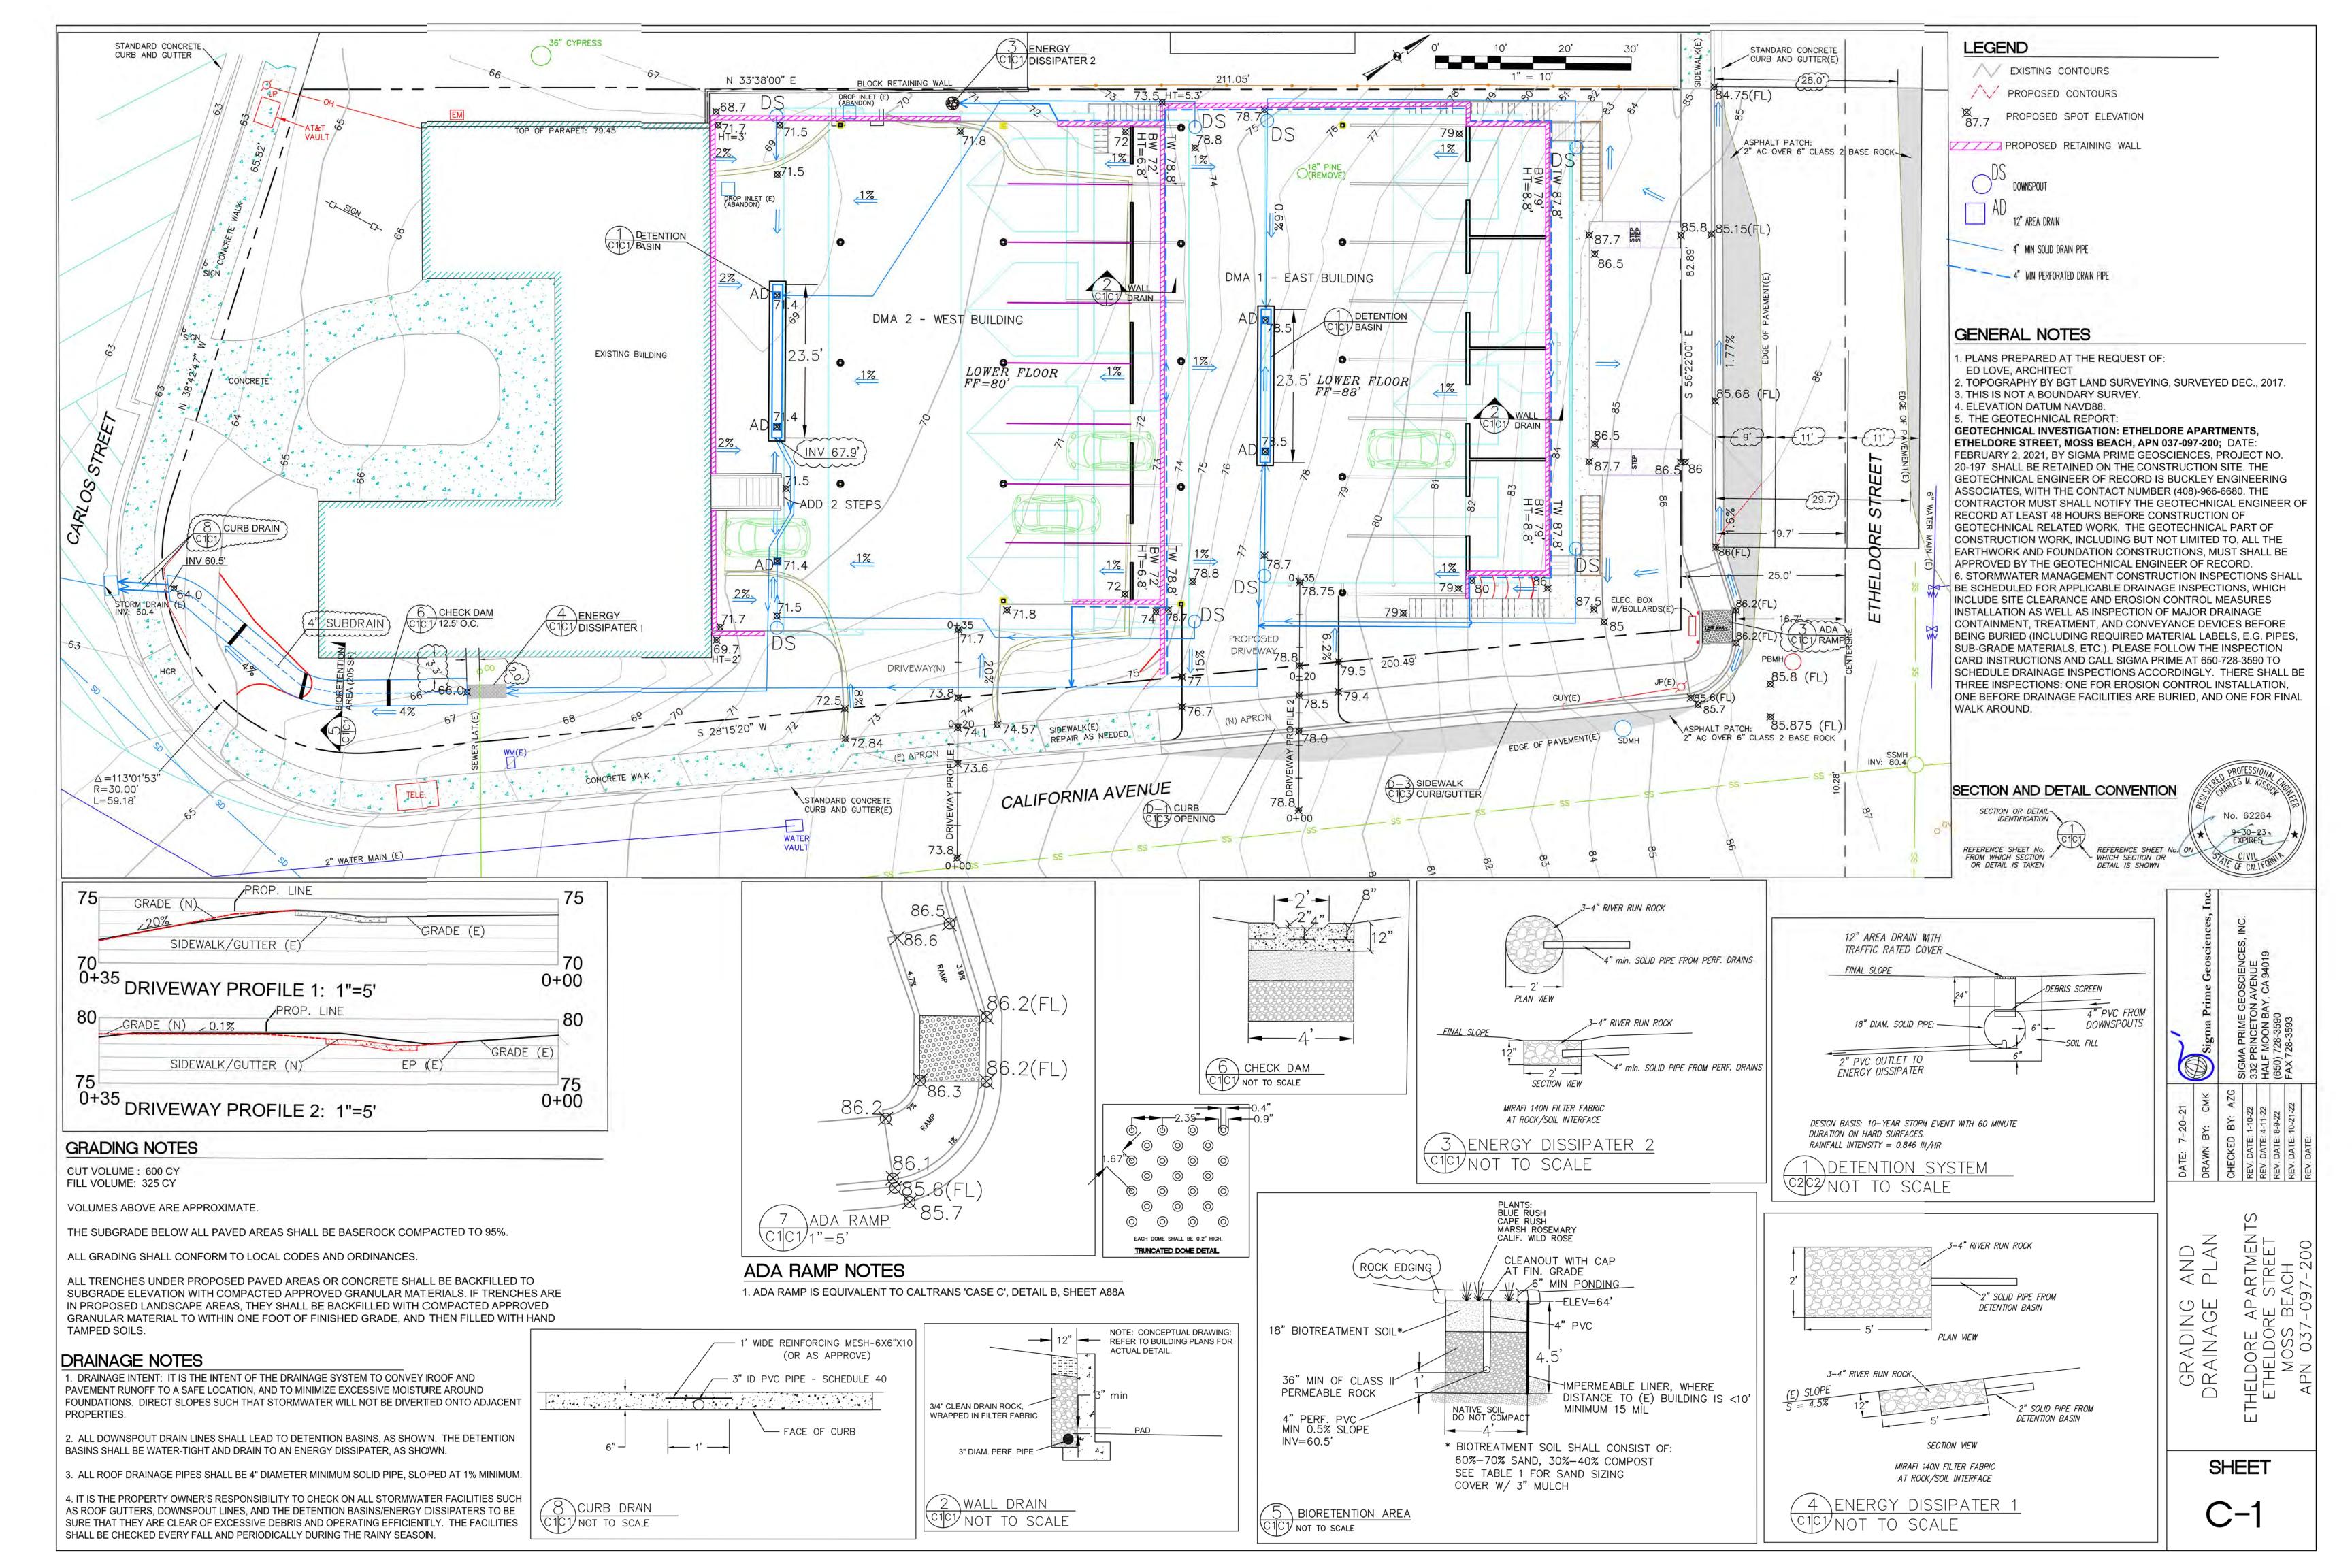
OF.






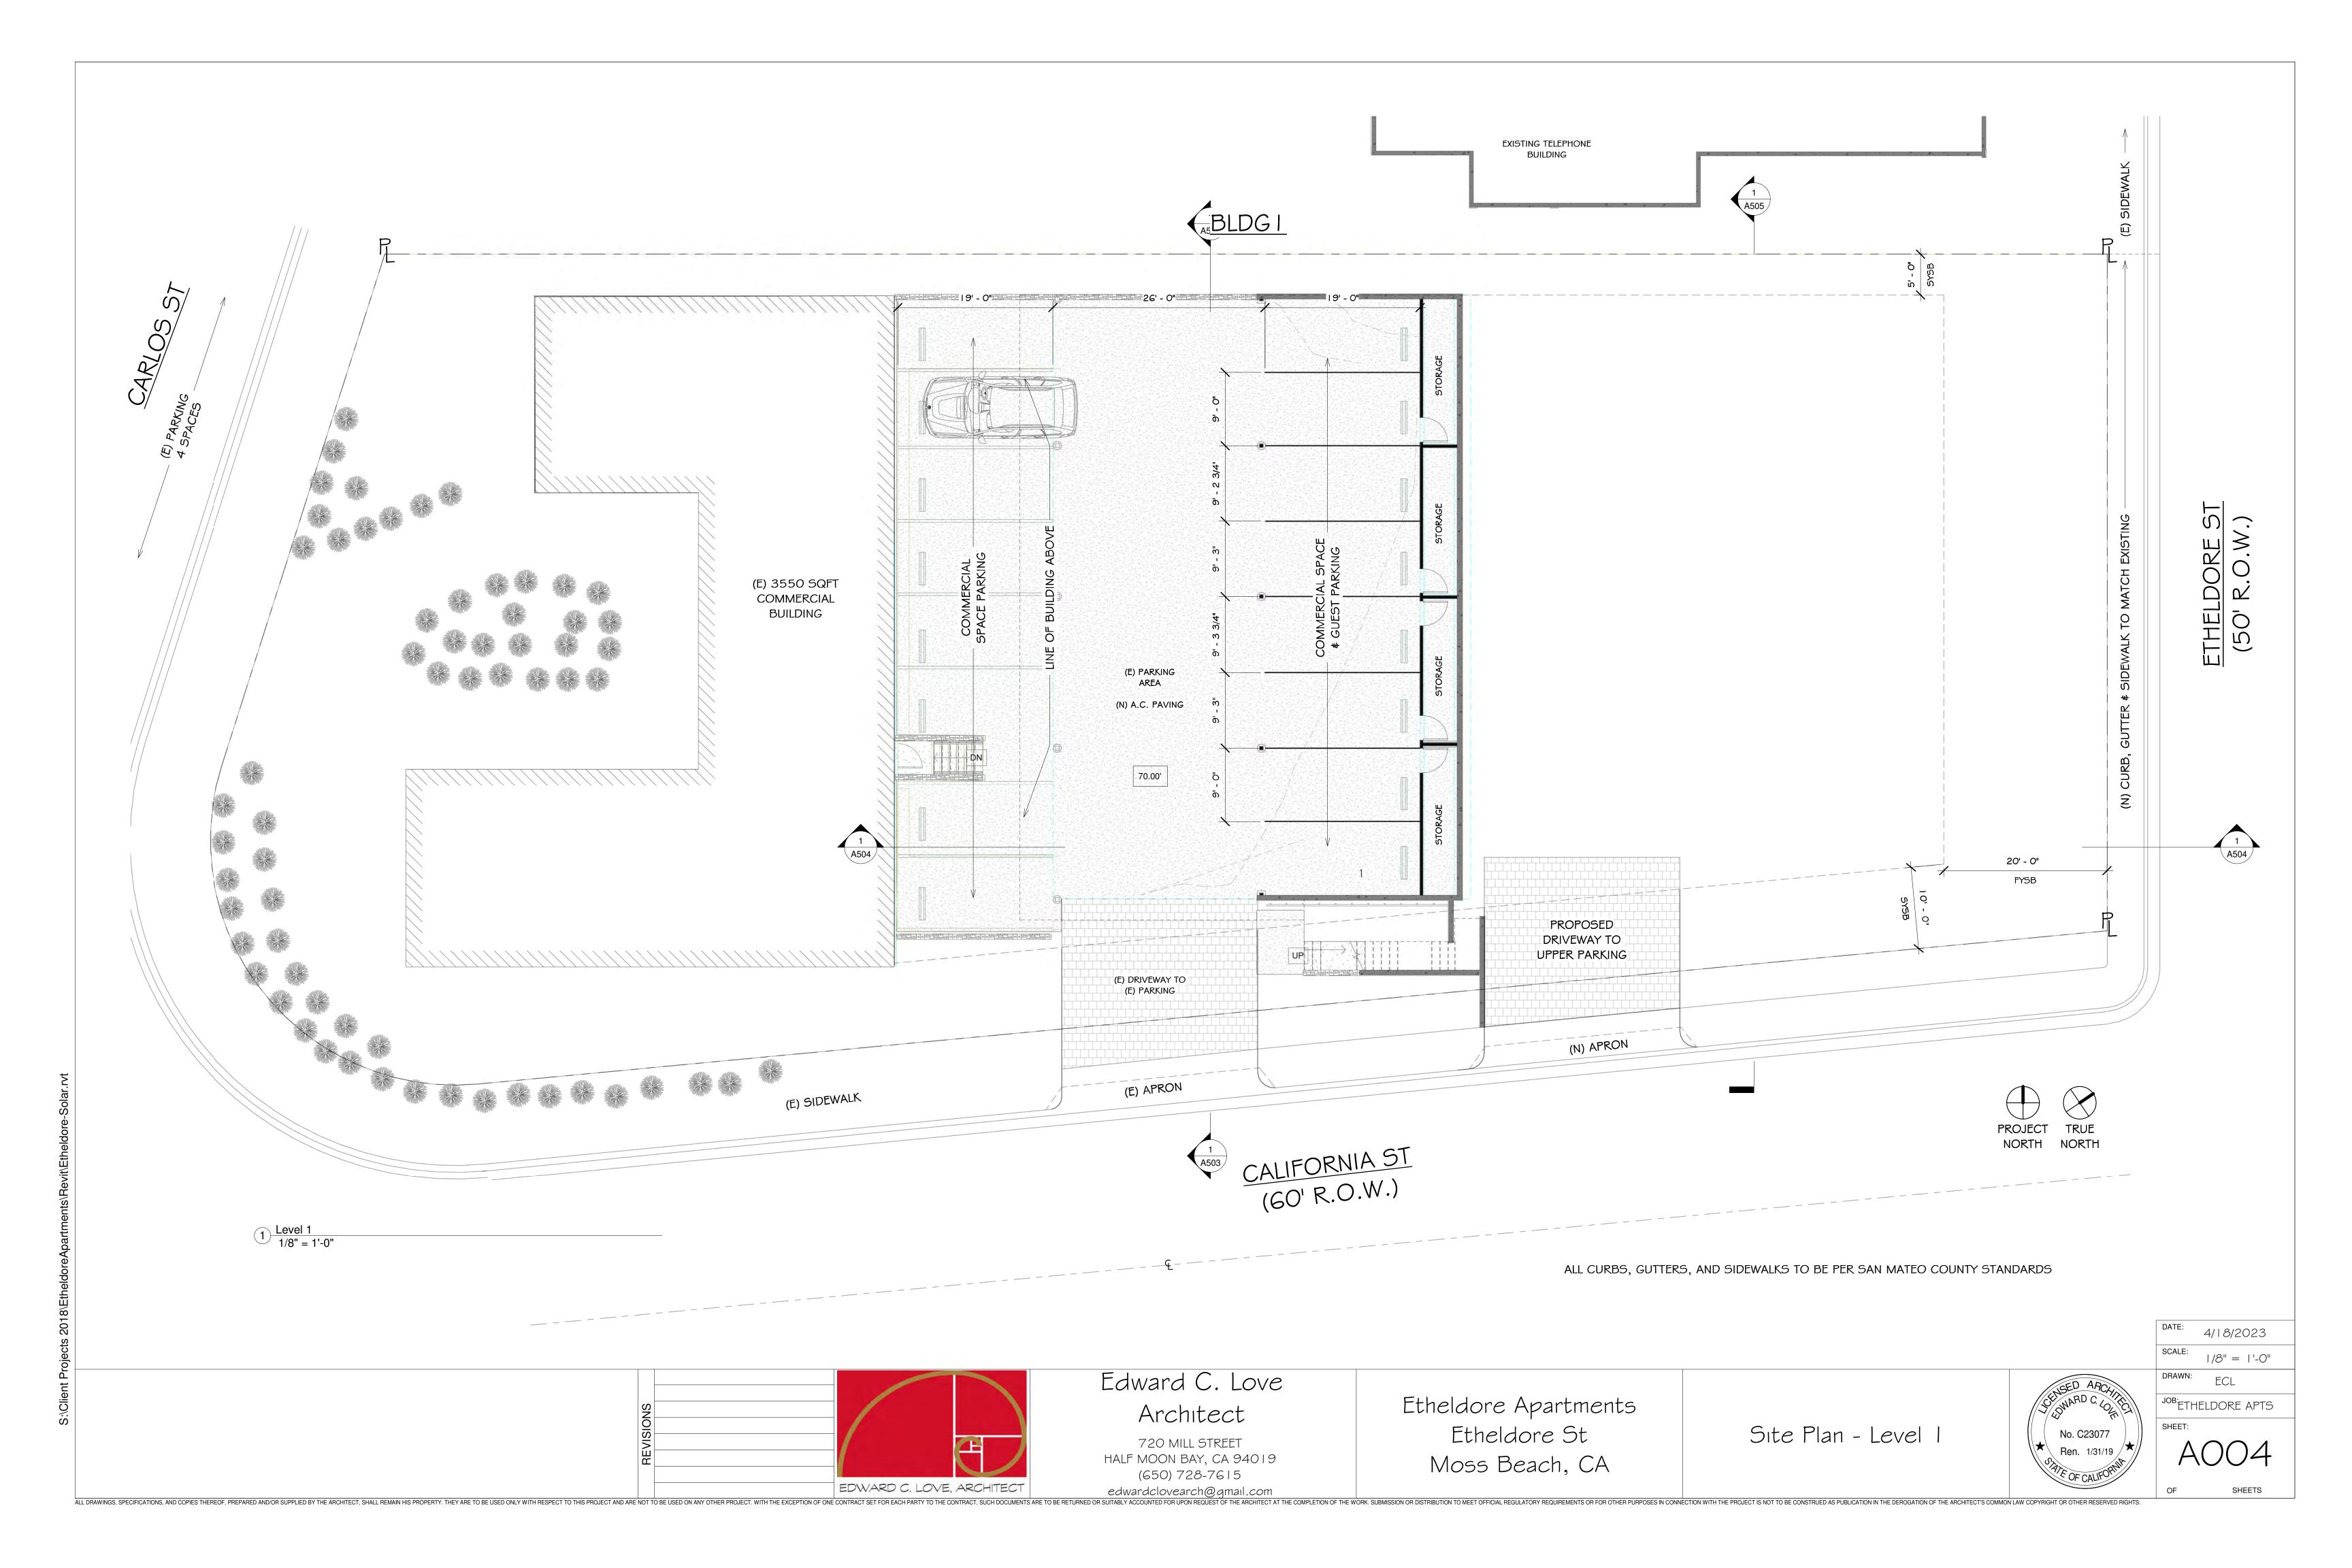


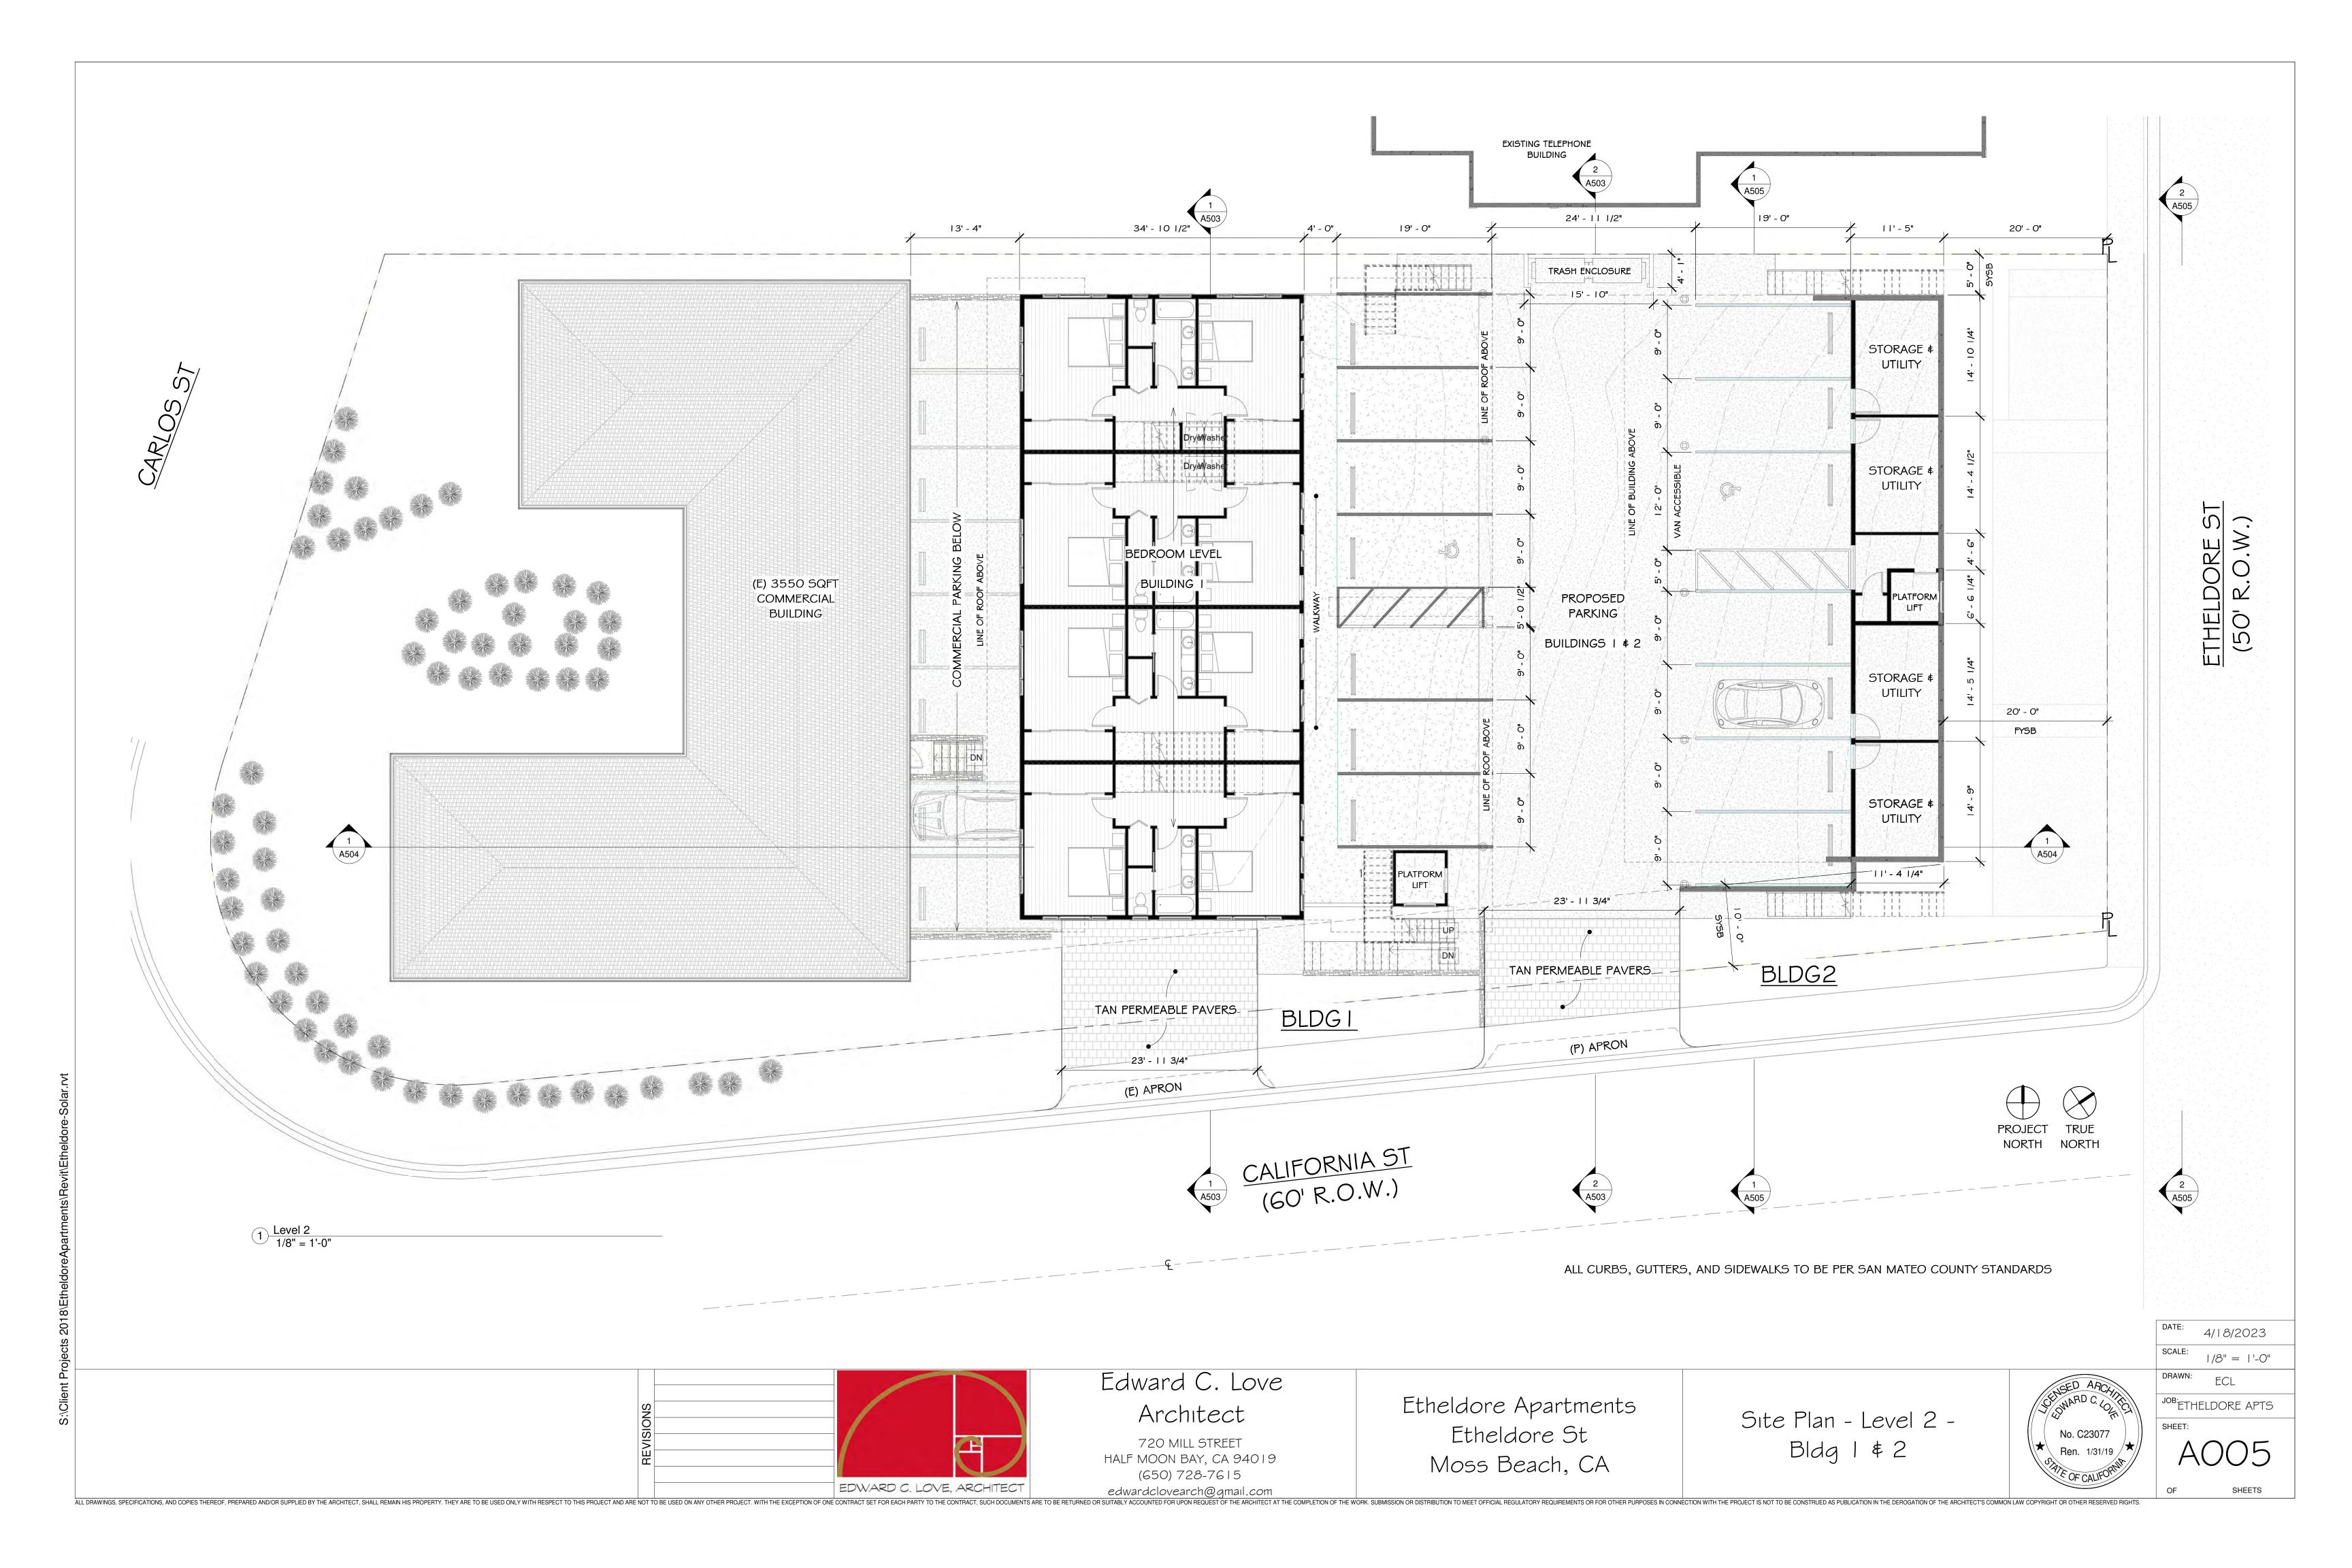

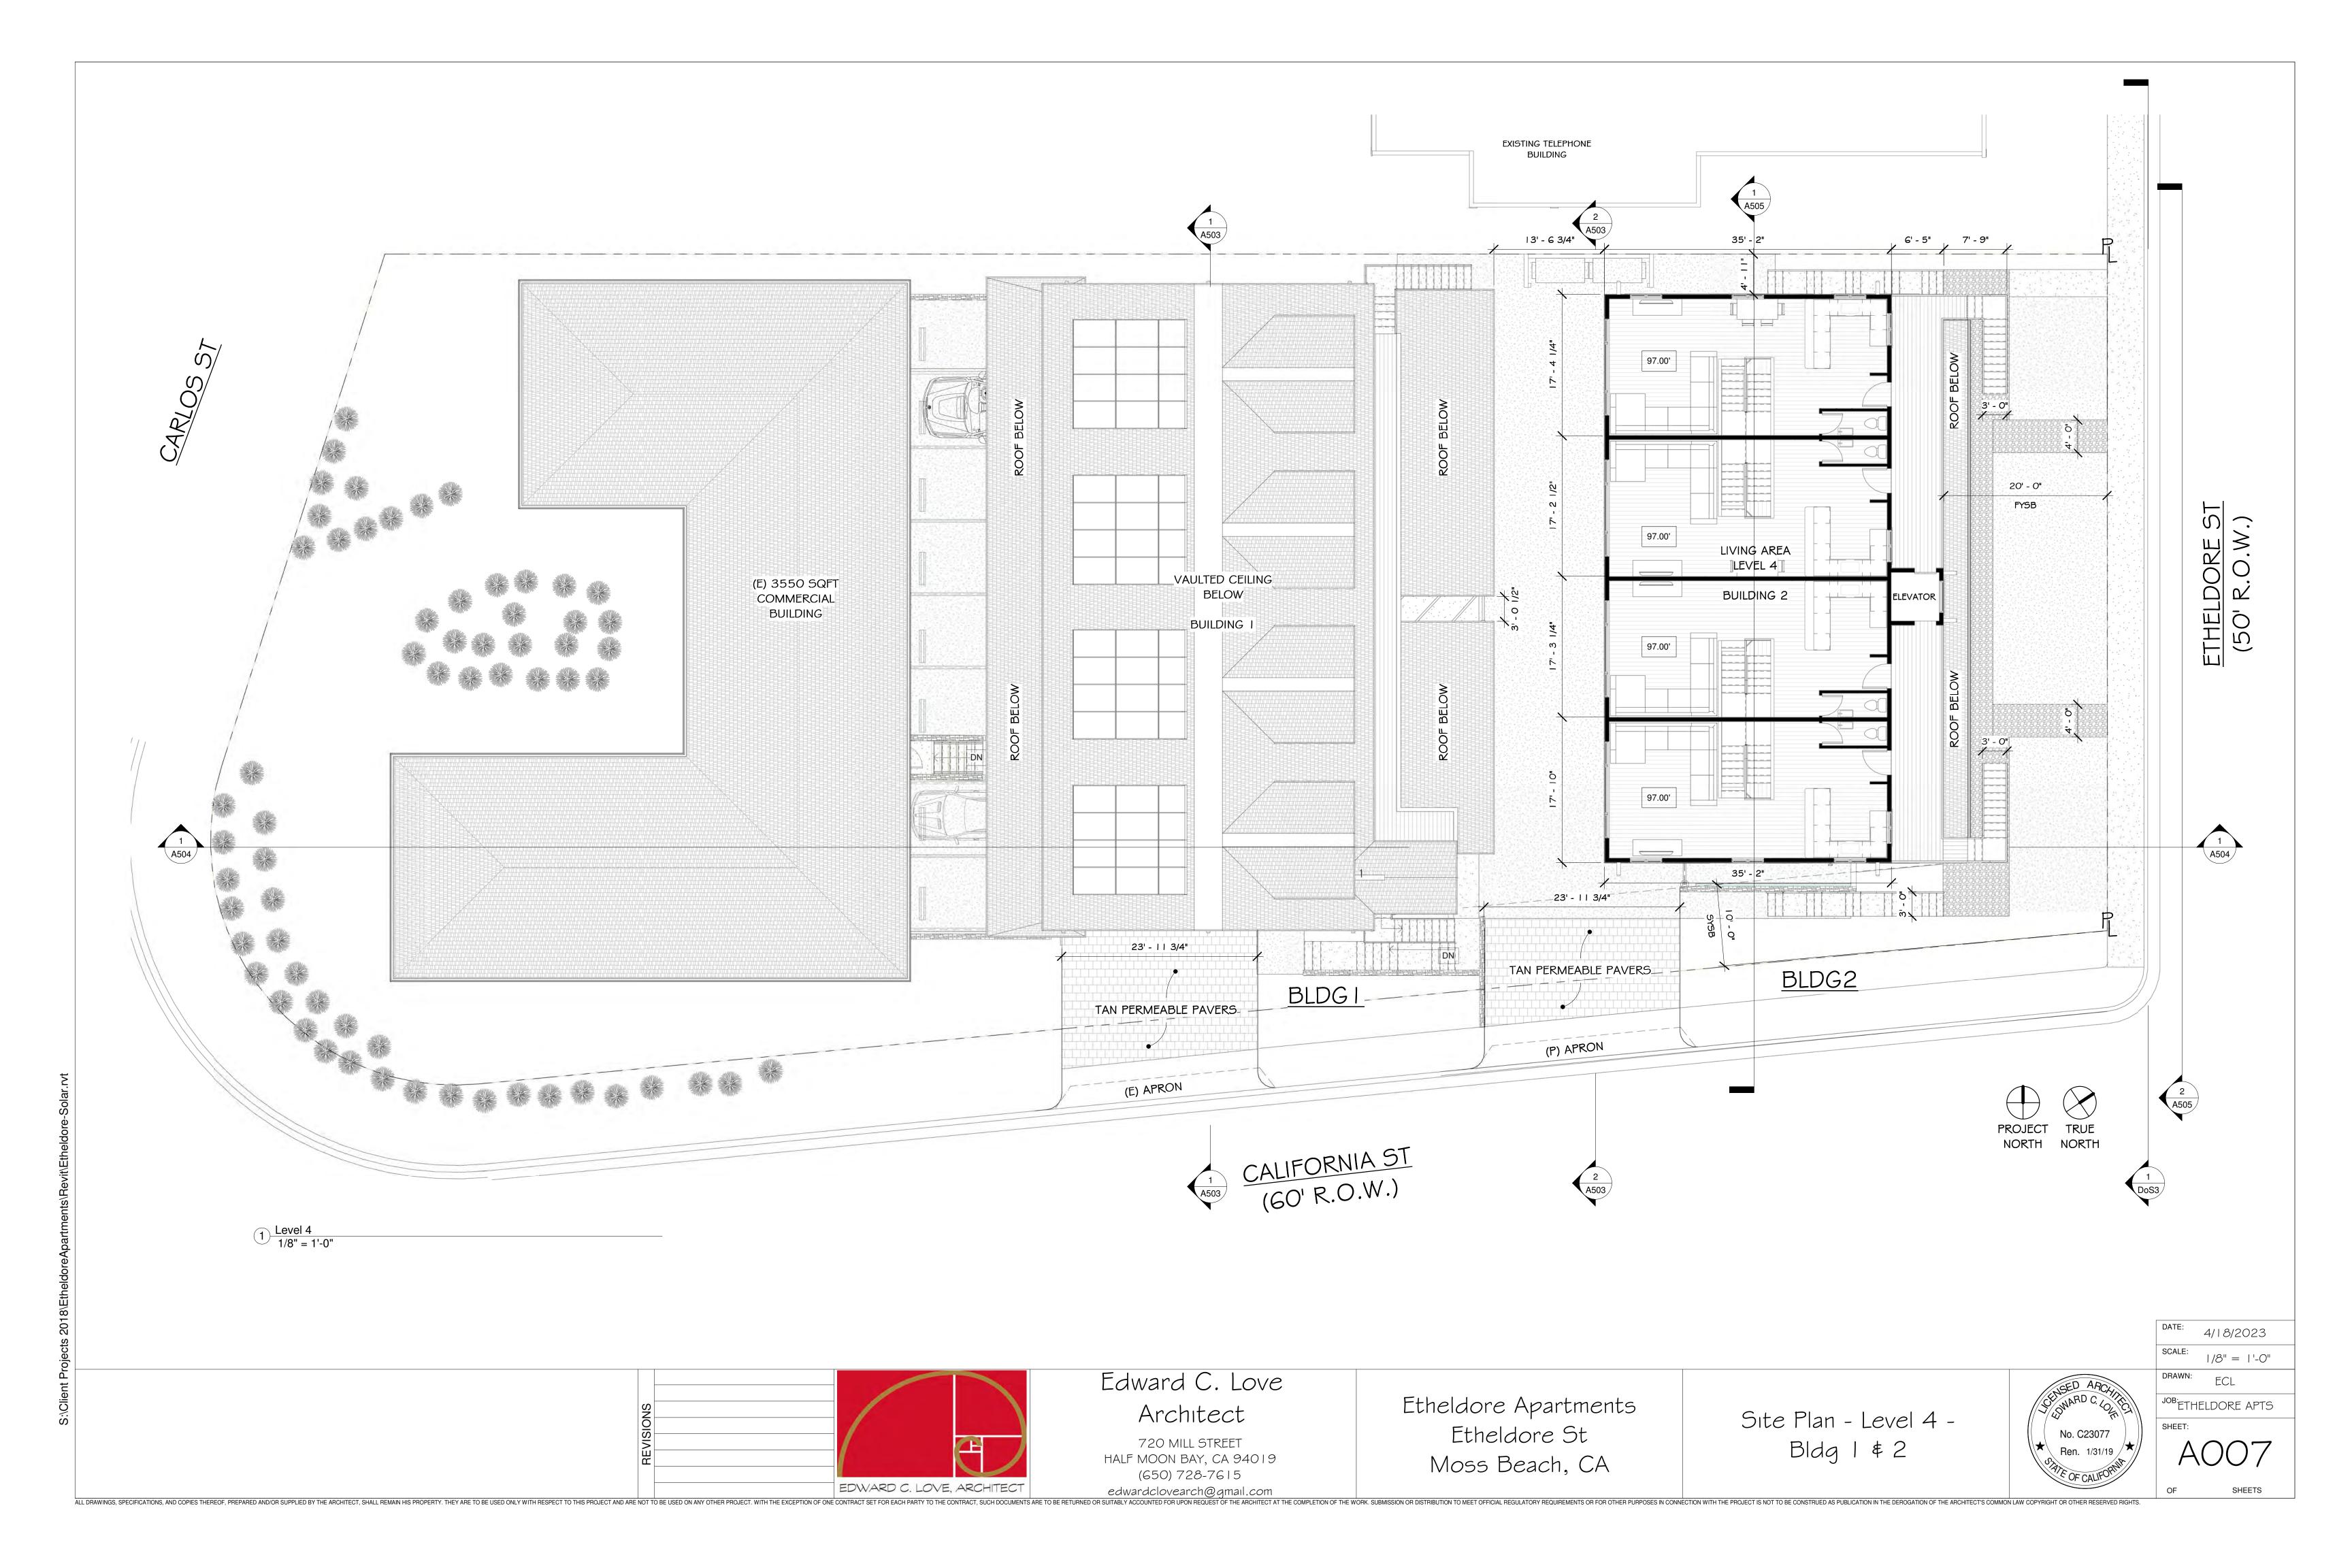


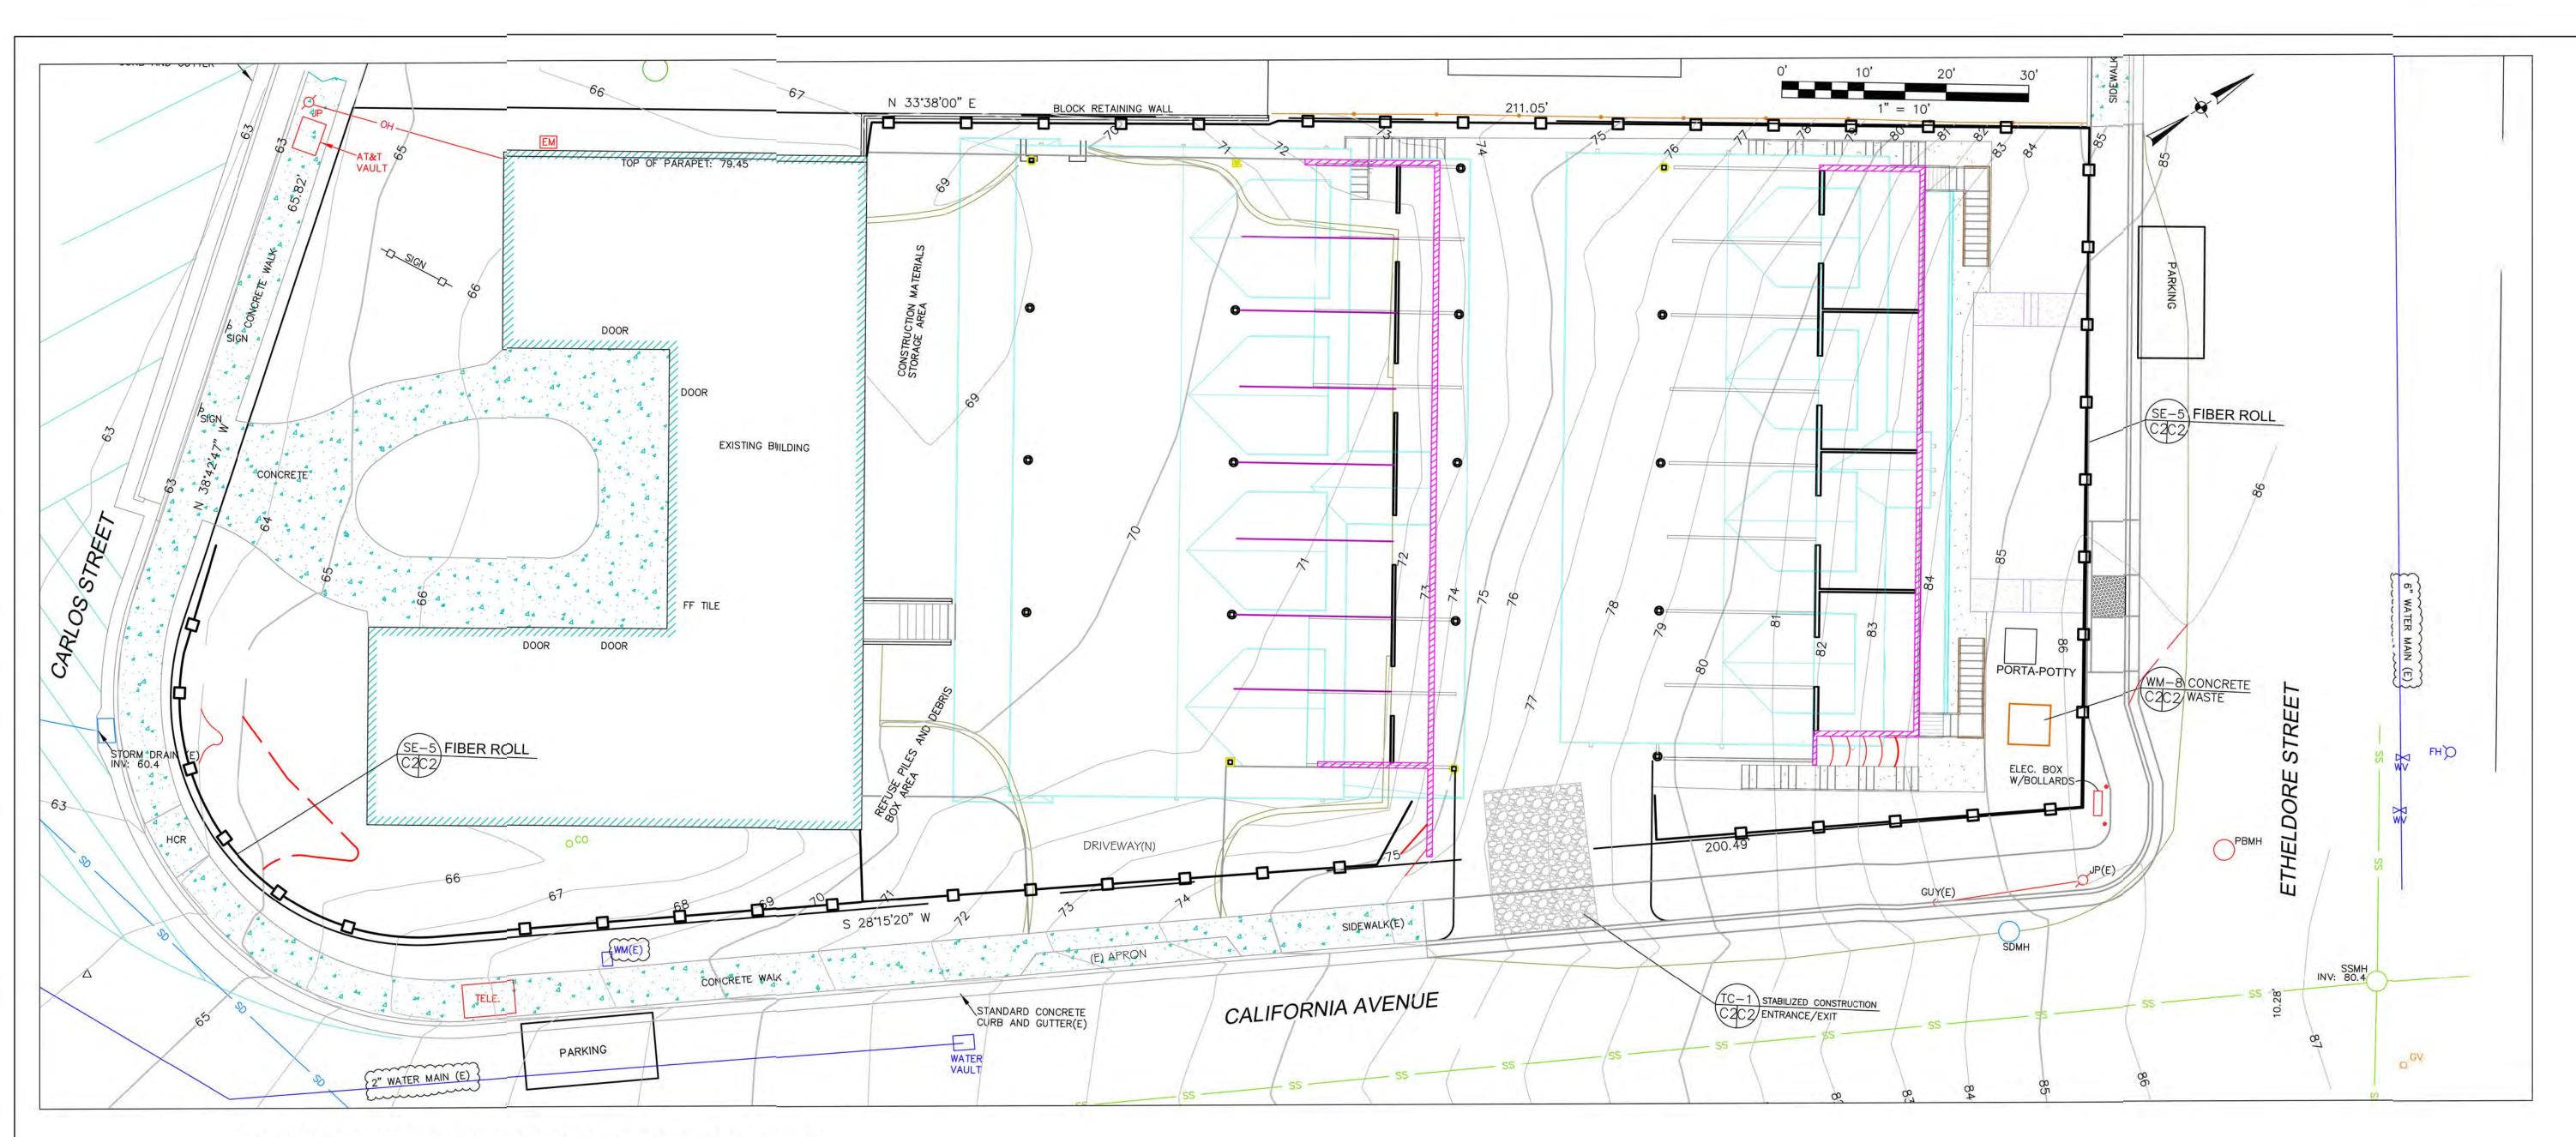


GENERAL EROSION AND SEDIMENT CONTROL NOTES

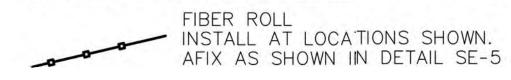


- There will be no stockpiling of soil. All excavated soil will be hauled off-site as it is excavated.
- Perform clearing and earth-moving activities only during dry weather. Measures to ensure adequate erosion and sediment control shall be installed prior to earth-moving activities and construction.
- Erosion control materials to be on-site during off-season.
- Measures to ensure adequate erosion and sediment control are required year-round. Stabilize all denuded areas and maintain erosion control measures continuously between October 1 and April 30.
- Store, handle, and dispose of construction materials and wastes properly so as to prevent their contact with stormwater.
- Control and prevent the discharge of all potential pollutants, including pavement cutting wastes, paints, concrete, petiroleum products, chemicals, wash water or sediments, and non-stormwater discharges to storm drains and watercourses.
- · Avoid cleaning, fueling, or maintaining vehicles on-site, except in a designated area where wash water is contained and treated.
- · Limit and time applications of pesticides and fertilizers to prevent polluted runoff.
- · Limit construction access routes to stabilized, designated access points
- · Avoid tracking dirt or other materials off-site; clean off-site paved areas and sidewalks using dry sweeping methods.
- · Train and provide instruction to all employees and subcontractors regarding the Watershed Protection Maintenance Standards and construction Best Management Fractices.
- · Placement of erosion materials is required on weekends and during rain events.
- The areas delineated on the plans for parking, grubbing, storage etc., shall not be enlarged or "run over."
- · Dust control is required year-round.
- Erosion control materials shall be stored on-site.
- · There are no trees or driplines on the site.

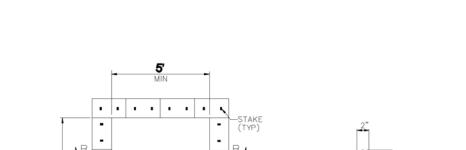

CONCRETE WASTE MANAGEMENT WM-8

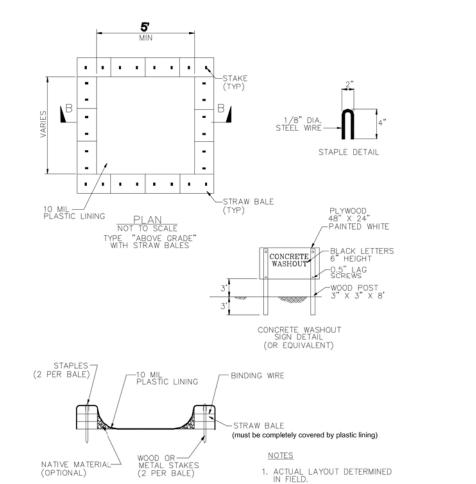


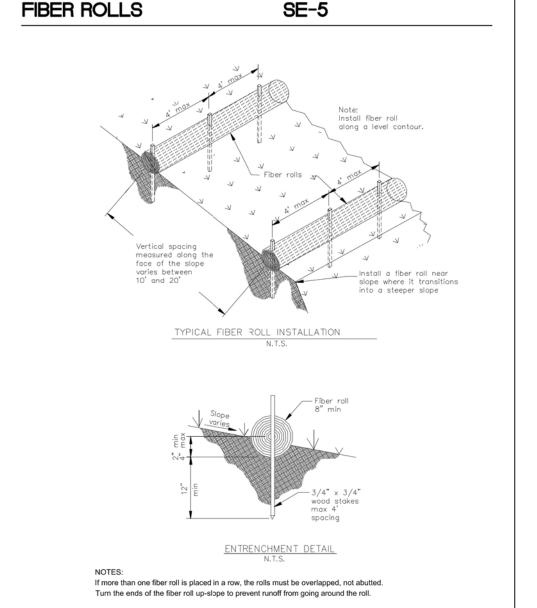

EROSION CONTROL POINT OF CONTACT

THIS PERSON WILL BE RESPONSIBLE FOR EROSION CONTROL AT THE SITE AND WILL BE THE COUNTY'S MAIN POINT OF CONTACT IF CORRECTIONS

NAME: CHARLES KISSICK _ TITLE/QUALIFICATION: ____CIVIL ENGINEER PHONE: 650-728-3590 E-MAIL:____SIGMAPRM@GMAIL.COM_

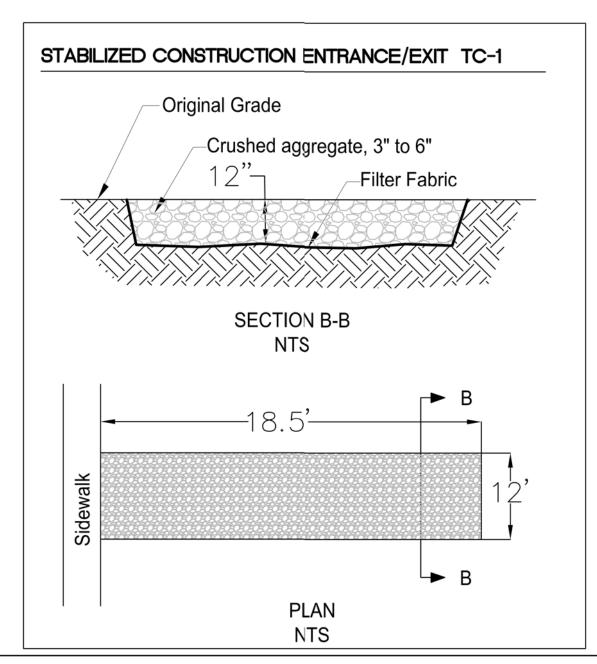





SEDIMENT PLAN AND TROL


EROSION CON

SHEET

C-2

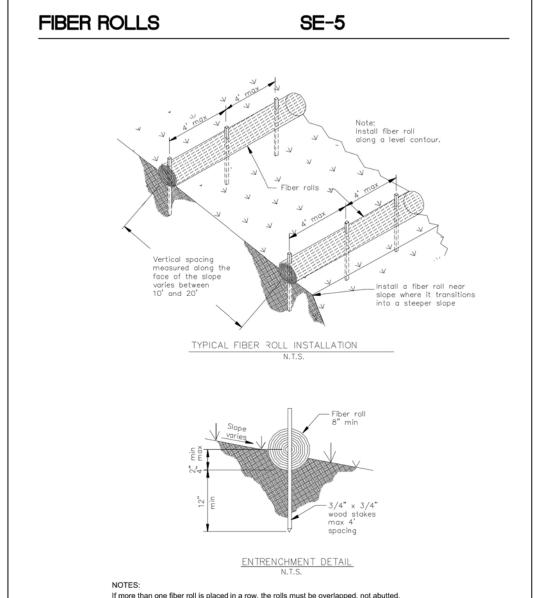


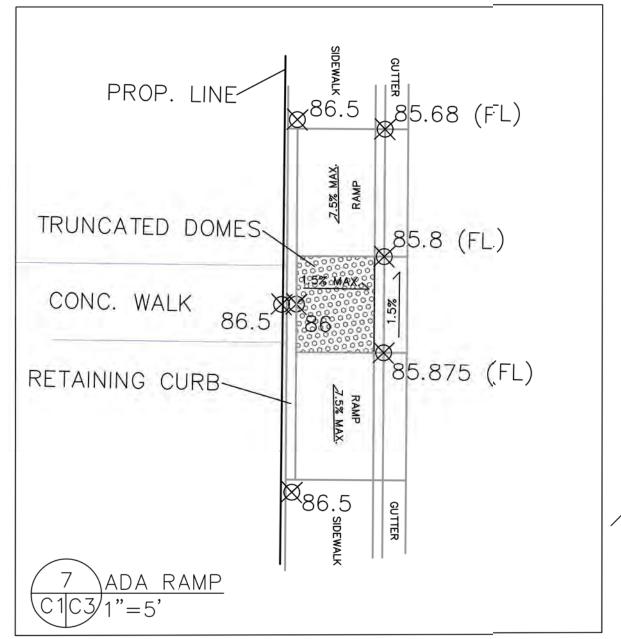


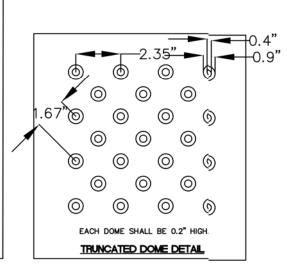


ADA RAMP NOTES

1. ADA RAMP IS EQUIVALENT TO CALTRANS 'CASE C', DETAIL IB, SHEET A88A

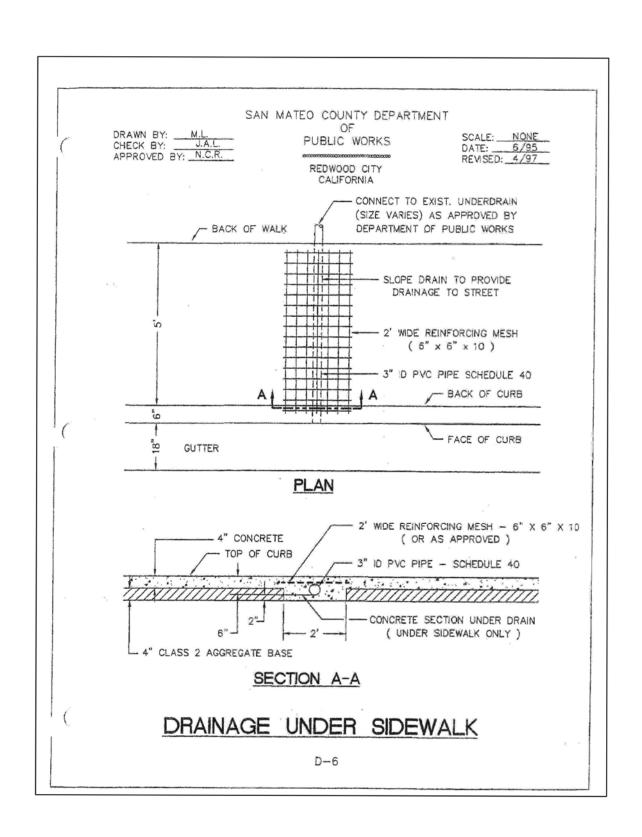

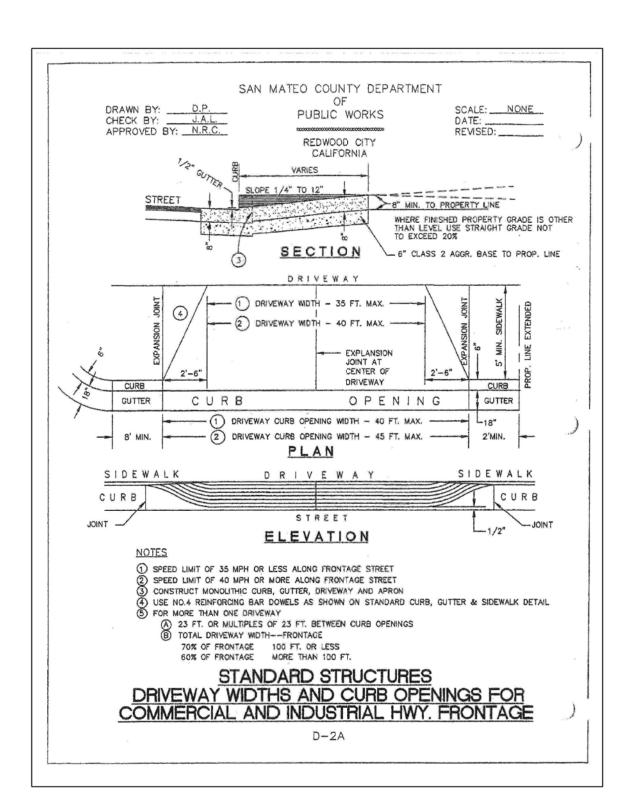

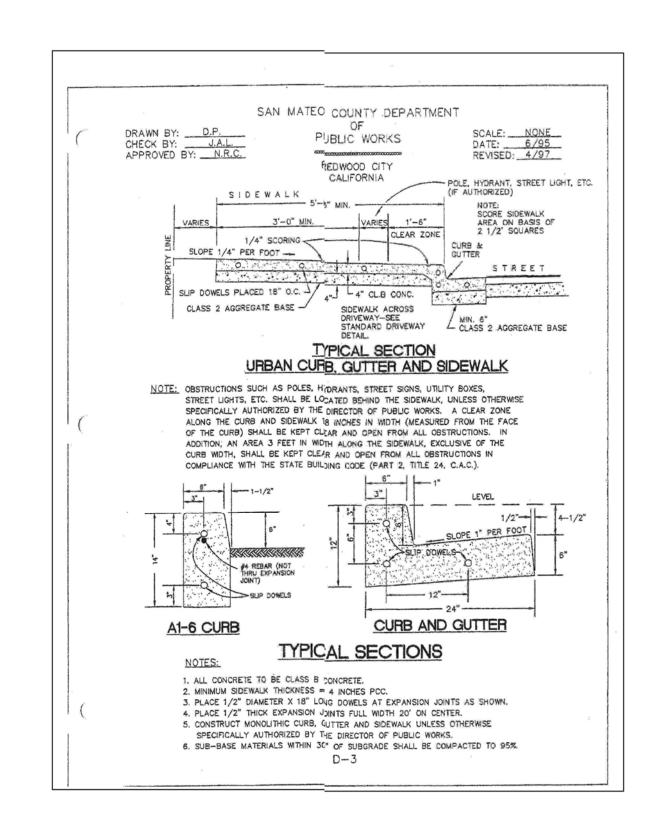



AWN BY: CMK

ECKED BY: AZG
SIGMA PRIME GEOSCIENCES, INC.
322 PRINCETON AVENUE
HALF MOON BAY, CA 94019
(650) 728-3593
FAX 728-3593

DETAILS
ETHELDORE APARTMENTS
ETHELDORE STREET
MOSS BEACH
APN 037-097-200

SHEET

C-3

4

Water Pollution Prevention Program Clean Water. Healthy Community

Construction Best Management Practices (BMPs)

Construction projects are required to implement the stormwater best management practices (BMP) on this page, as they apply to your project, all year long.

Materials & Waste Management



Non-Hazardous Materials

☐ Berm and cover stockpiles of sand, dirt or other construction material with tarps when rain is forecast or if not actively being used within

☐ Use (but don't overuse) reclaimed water for dust control.

Hazardous Materials

- ☐ Label all hazardous materials and hazardous wastes (such as pesticides, paints, thinners, solvents, fuel, oil, and antifreeze) in accordance with city, county, state and federal regulations.
- ☐ Store hazardous materials and wastes in water tight containers, store in appropriate secondary containment, and cover them at the end of every work day or during wet weather or when rain is forecast.
- ☐ Follow manufacturer's application instructions for hazardous materials and be careful not to use more than necessary. Do not apply chemicals outdoors when rain is forecast within 24 hours. ☐ Arrange for appropriate disposal of all hazardous wastes.

Waste Management

- ☐ Cover waste disposal containers securely with tarps at the end of every work day and during wet weather.
- ☐ Check waste disposal containers frequently for leaks and to make sure they are not overfilled. Never hose down a dumpster on the construction site.
- ☐ Clean or replace portable toilets, and inspect them frequently for leaks and spills.
- ☐ Dispose of all wastes and debris properly. Recycle materials and wastes that can be recycled (such as asphalt, concrete, aggregate base materials, wood, gyp board, pipe, etc.)
- ☐ Dispose of liquid residues from paints, thinners, solvents, glues, and cleaning fluids as hazardous waste.

Construction Entrances and Perimeter

- ☐ Establish and maintain effective perimeter controls and stabilize all construction entrances and exits to sufficiently control erosion and sediment discharges from site and tracking off site.
- ☐ Sweep or vacuum any street tracking immediately and secure sediment source to prevent further tracking. Never hose down streets to clean up tracking.

Equipment Management &




- ☐ Designate an area, fitted with appropriate BMPs, for vehicle and equipment parking and storage. Perform major maintenance, repair jobs, and vehicle
- and equipment washing off site. ☐ If refueling or vehicle maintenance must be done onsite, work in a bermed area away from storm drains and over a drip pan or drop cloths big enough to collect
- fluids. Recycle or dispose of fluids as hazardous waste. ☐ If vehicle or equipment cleaning must be done onsite, clean with water only in a bermed area that will not allow rinse water to run into gutters, streets, storm drains, or surface waters.
- ☐ Do not clean vehicle or equipment onsite using soaps, solvents, degreasers, or steam cleaning equipment.

Spill Prevention and Control

- Keep spill cleanup materials (e.g., rags, absorbents and cat litter) available at the construction site at all times. Inspect vehicles and equipment frequently for and repair leaks promptly. Use drip pans to catch leaks
- until repairs are made. Clean up spills or leaks immediately and dispose of cleanup materials properly. Do not hose down surfaces where fluids have spilled.

Use dry cleanup methods (absorbent materials, cat

- litter, and/or rags). Sweep up spilled dry materials immediately. Do not try to wash them away with water, or bury them. Clean up spills on dirt areas by digging up and
- properly disposing of contaminated soil. ☐ Report significant spills immediately. You are required by law to report all significant releases of hazardous materials, including oil. To report a spill; 1) Dial 911 or your local emergency response number, 2) Call the Governor's Office of Emergency Services Warning Center, (800) 852-7550 (24 hours).

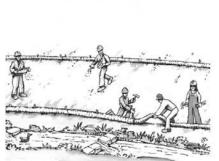

- ☐ Schedule grading and excavation work during dry weather. ☐ Stabilize all denuded areas, install and
- maintain temporary erosion controls (such as erosion control fabric or bonded fiber matrix) until vegetation is established. ☐ Remove existing vegetation only when
 - absolutely necessary, and seed or plant vegetation for erosion control on slopes or where construction is not immediately ☐ Prevent sediment from migrating offsite and protect storm drain inlets, gutters,
 - ditches, and drainage courses by installing as fiber rolls, silt fences, sediment basins, gravel bags, berms, etc.

to dump trucks on site, not in the streets.

- ☐ If any of the following conditions are observed, test for contamination and contact the Regional Water Quality Control Board:
- Unusual soil conditions, discoloration, or odor. - Abandoned underground tanks.

- Buried barrels, debris, or trash.

Storm drain polluters may be liable for fines of up to \$10,000 per day!

☐ When washing exposed aggregate, Sawcutting & Asphalt/Concrete Removal

☐ Protect nearby storm drain inlets when saw cutting. Use filter fabric, catch basin out of the storm drain system.

☐ If sawcut slurry enters a catch basin, clean

Avoid paving and seal coating in wet

weather or when rain is forecast, to

prevent materials that have not cured

from contacting stormwater runoff.

☐ Collect and recycle or appropriately

seal, fog seal, etc.

☐ Cover storm drain inlets and manholes

when applying seal coat, tack coat, slurry

dispose of excess abrasive gravel or sand.

Do NOT sweep or wash it into gutters.

☐ Do not use water to wash down fresh

asphalt concrete pavement.

slurry and dispose of all waste as soon ☐ Keep excavated soil on site and transfer it as you are finished in one location or at the end of each work day (whichever is

it up immediately.

Landscaping

Concrete, Grout & Mortar

☐ Store concrete, grout, and mortar away

☐ Wash out concrete equipment/trucks

offsite or in a designated washout

area, where the water will flow into a

temporary waste pit, and in a manner

underlying soil or onto surrounding areas.

Let concrete harden and dispose of as

drains. Block any inlets and vacuum

gutters, hose washwater onto dirt areas, or

drain onto a bermed surface to be pumped

that will prevent leaching into the

rain, runoff, and wind.

from storm drains or waterways, and on

pallets under cover to protect them from

- ☐ Protect stockpiled landscaping materials from wind and rain by storing them under tarps all year-round.
- ☐ Stack bagged material on pallets and ☐ Discontinue application of any erodible landscape material within 2 days before a forecast rain event or during wet weather.

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Painting Cleanup and Removal

- containers into a street, gutter, storm drain, or stream. to the extent possible, and rinse into a
- Never pour paint down a storm drain. ☐ For oil-based paints, paint out brushes to the extent possible and clean with thinner
- excess liquids as hazardous waste. ☐ Paint chips and dust from non-hazardous dry stripping and sand blasting may be swept up or collected in plastic drop
- and dust from marine paints or paints containing lead, mercury, or tributyltin must be disposed of as hazardous waste. Lead based paint removal requires a state-

Dewatering

- from all disturbed areas. ■ When dewatering, notify and obtain approval from the local municipality
- ☐ In areas of known or suspected contamination, call your local agency to determine whether the ground water must be tested. Pumped groundwater may need to be collected and hauled off-site for treatment and proper disposal.

Painting & Paint Removal



☐ Never clean brushes or rinse paint

☐ For water-based paints, paint out brushes drain that goes to the sanitary sewer.

or solvent in a proper container. Filter and reuse thinners and solvents. Dispose of

cloths and disposed of as trash. ☐ Chemical paint stripping residue and chips

☐ Discharges of groundwater or captured runoff from dewatering operations must be properly managed and disposed. When possible send dewatering discharge to landscaped area or sanitary sewer. If discharging to the sanitary sewer call your local wastewater treatment plant.

☐ Divert run-on water from offsite away

before discharging water to a street gutter or storm drain. Filtration or diversion through a basin, tank, or sediment trap may be required.

Requirements for Architectural Copper

Protect water quality during installation, cleaning, treating, and washing!

Copper from Buildings May Harm Aquatic Life

Use Best Management Practices (BMPs)

Copper can harm aquatic life in San Francisco Bay. Water that comes into contact with architectural copper may contribute to impacts, especially during installation, cleaning, treating, or washing. Patination solutions that are used to obtain the desired shade of green or brown typically contain acids. After treatment, when the copper is rinsed to remove these acids, the rinse water is a source of pollutants. Municipalities prohibit discharges to the storm drain of water used in the installation, cleaning, treating and washing of architectural copper.



The following Best Management Practices (BMPs) must be implemented to prevent prohibited discharges to storm drains.

During Installation

- If possible, purchase copper materials that have been pre-patinated at the factory.
- If patination is done on-site, implement one or more of the following BMPs:
- Discharge the rinse water to landscaping. Ensure that the rinse water does not flow to the street or storm drain. Block off storm drain inlet if needed. o Collect rinse water in a tank and pump to the sanitary
- sewer. Contact your local sanitary sewer agency before discharging to the sanitary sewer.
- o Collect the rinse water in a tank and haul off-site for proper disposal. Consider coating the copper materials with an impervious coating that prevents further corrosion and runoff. This will Storm drain inlet is blocked to prevent



also maintain the desired color for a longer time, requiring prohibited discharge. The water must be pumped and disposed of properly.

During Maintenance

Implement the following BMPs during routine maintenance activities, such as power washing the roof, re-patination or re-application of impervious coating:

- Block storm drain inlets as needed to prevent runoff from entering storm drains.
- Discharge the wash water to landscaping or to the sanitary sewer (with permission from the local sanitary sewer agency). If this is not an option, haul the wash water off-site for proper disposal.

Protect the Bay/Ocean and yourself!

If you are responsible for a discharge to the storm drain of nonstormwater generated by installing, cleaning, treating or washing copper architectural features, you are in violation of the municipal stormwater ordinance and may be subject to a fine.





Contact Information The San Mateo Countywide Water Pollution Prevention Program lists municipal stormwater contacts at www.flowstobay.org (click on "Business", then "New Development", then "local permitting agency").

FINAL February 29, 2012


ECL



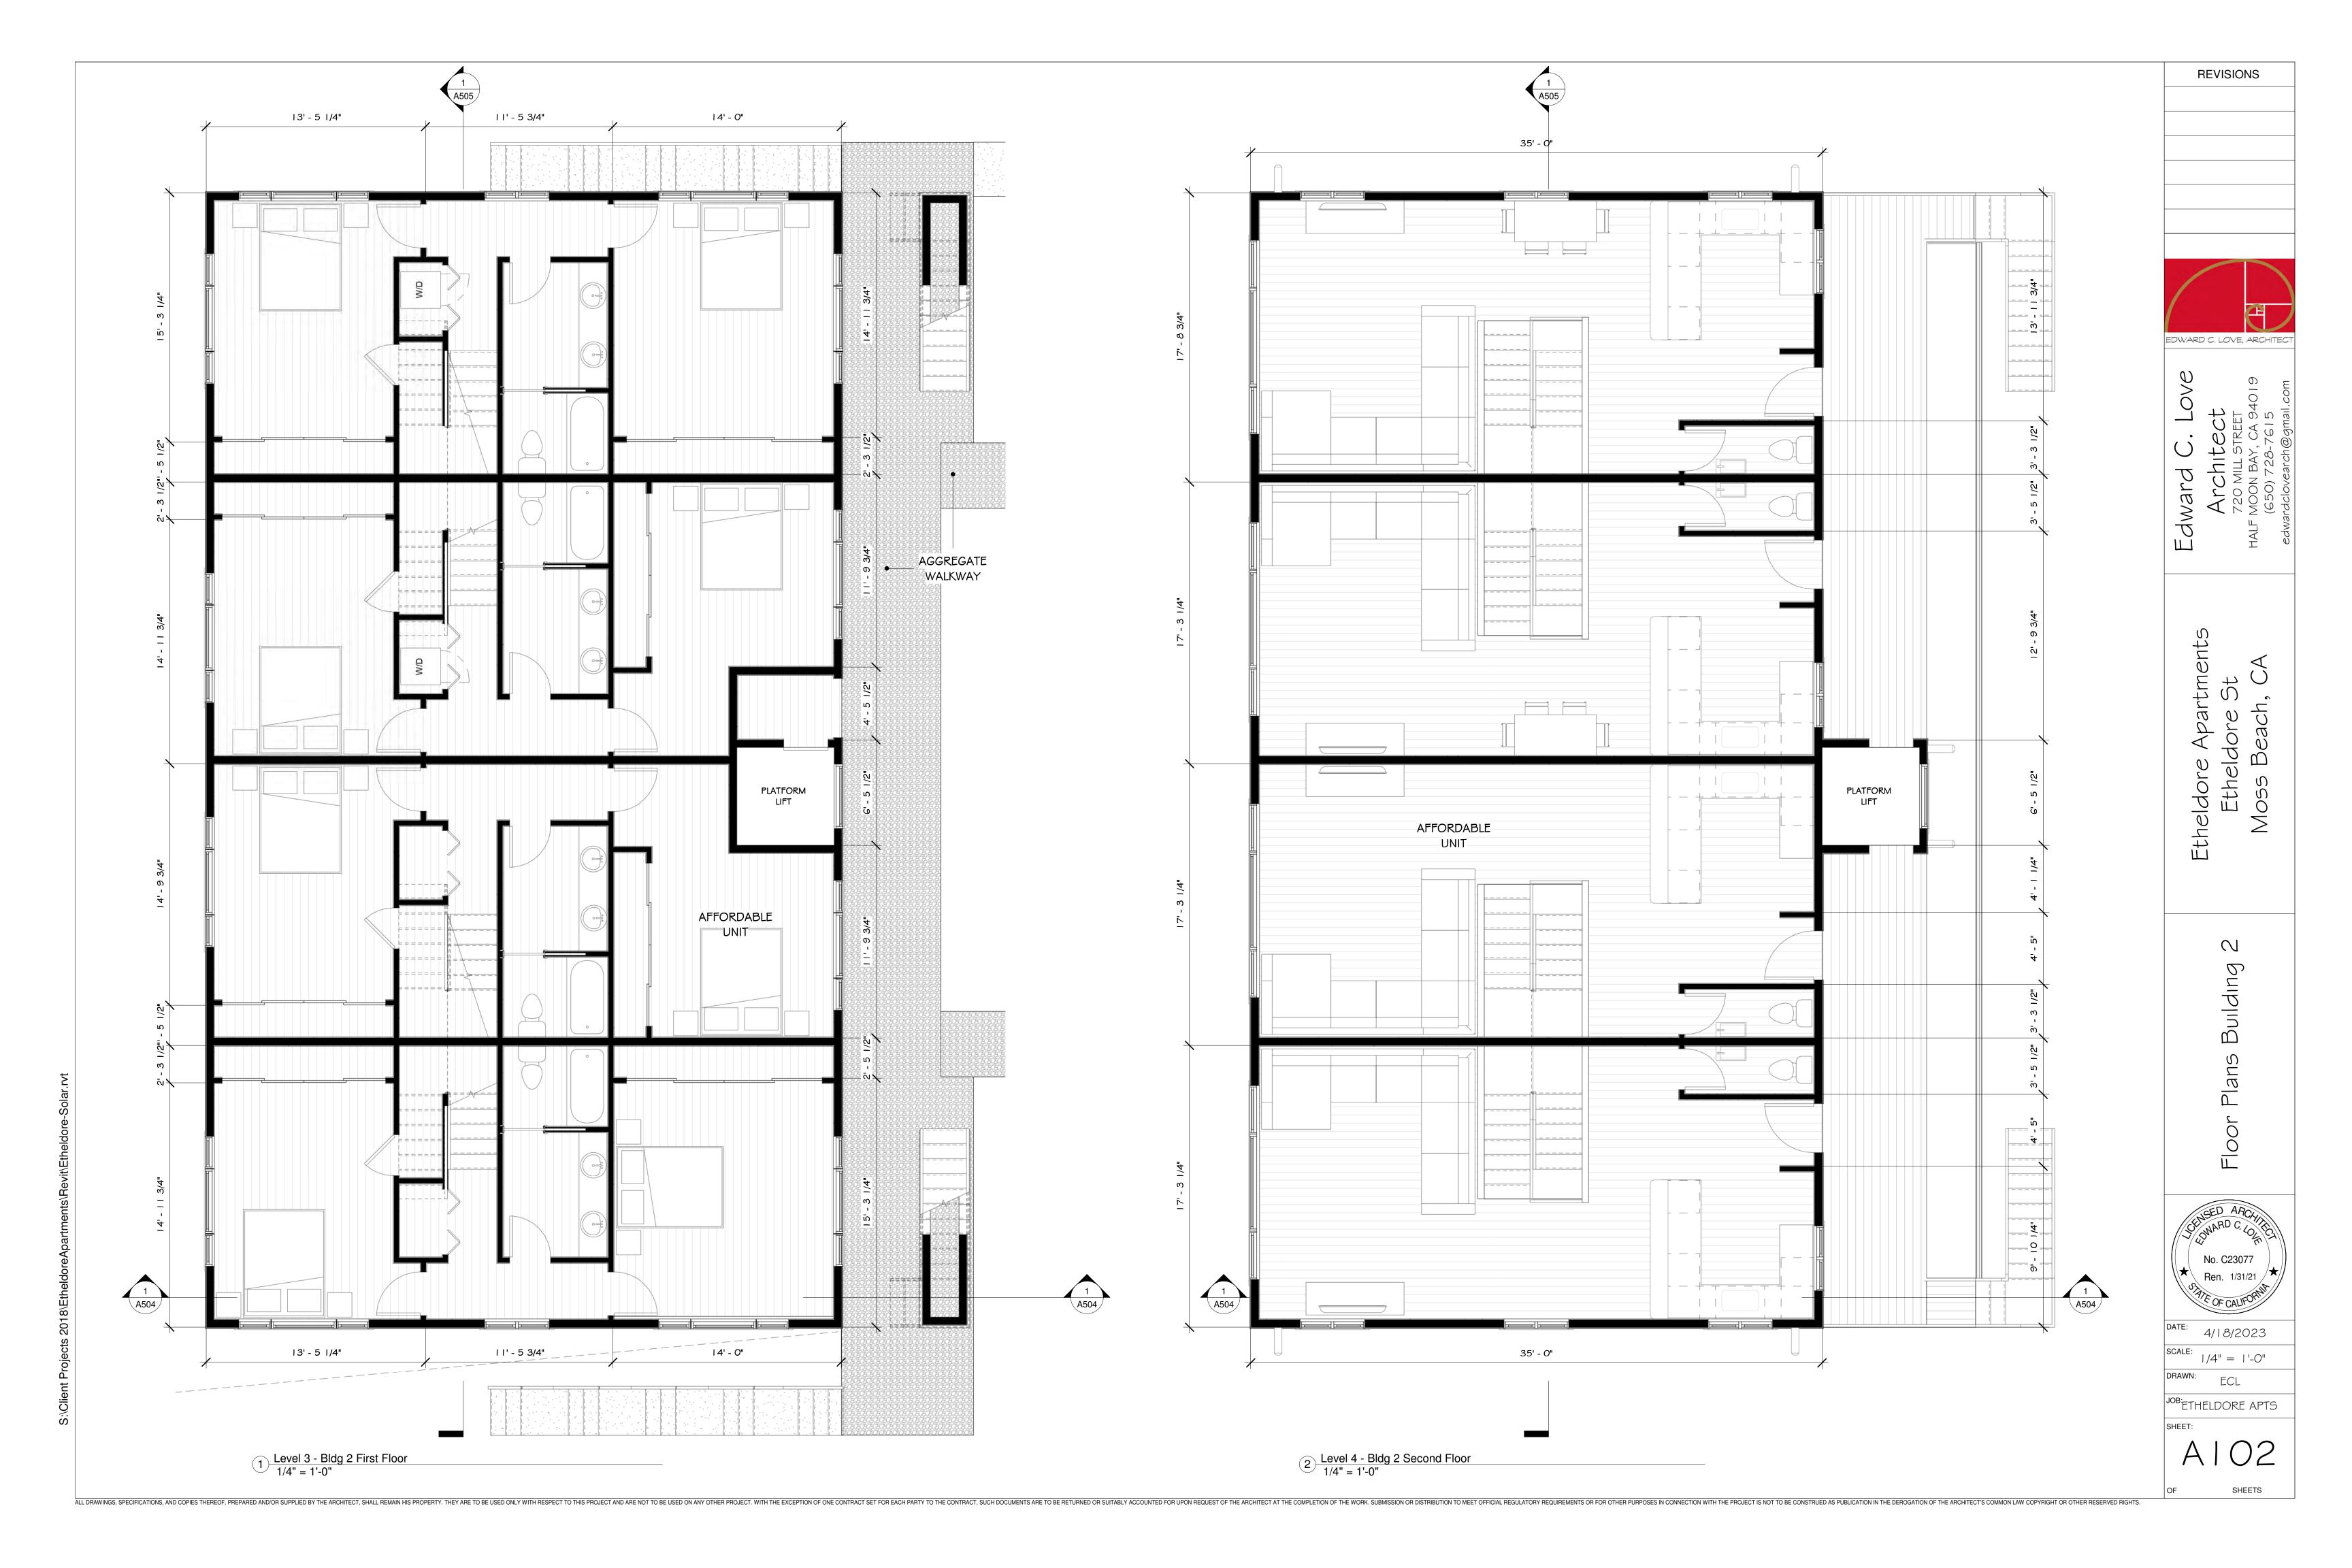

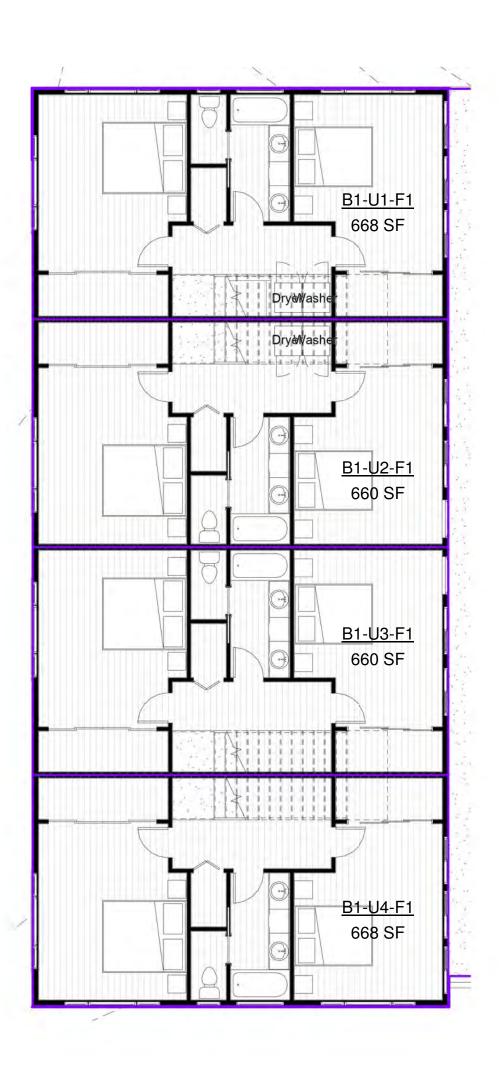


1 Level 2 - Area Plan 1/8" = 1'-0"

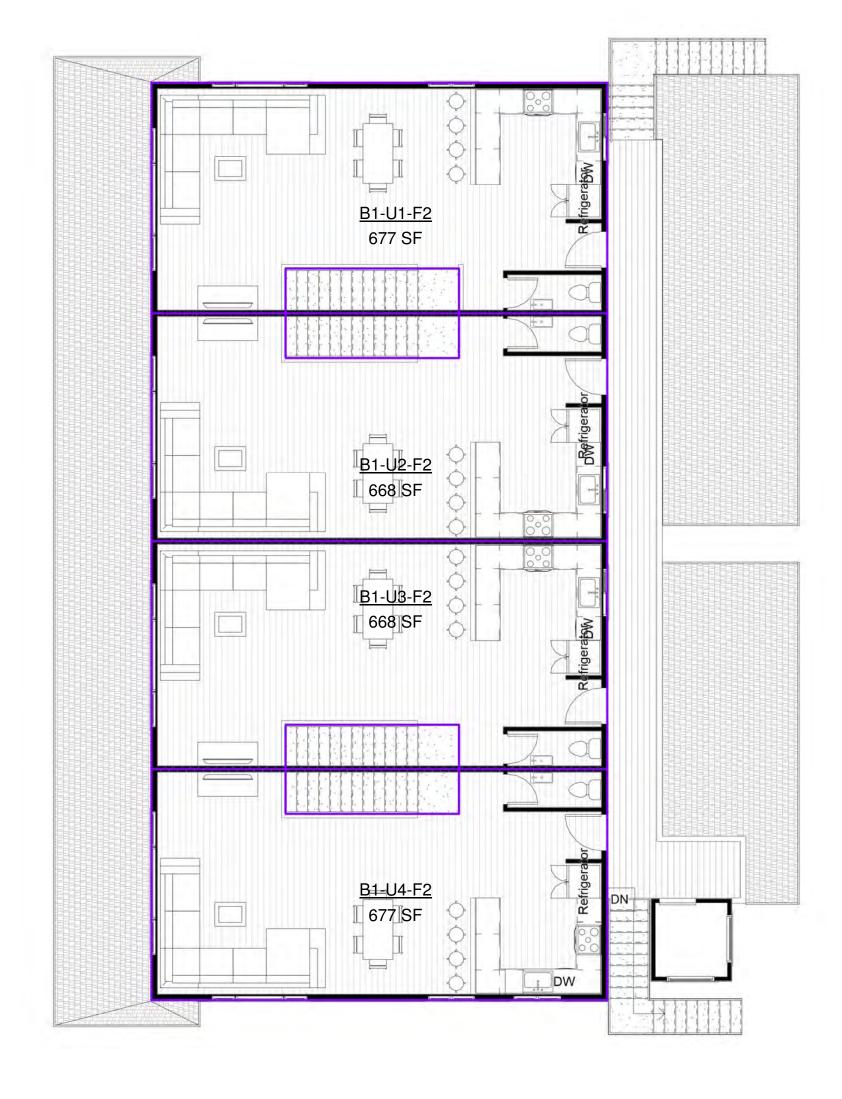


2 Level 3 - Area Plan 1/8" = 1'-0"

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3 <u>Level 4 - Area Plan</u> 1/8" = 1'-0"

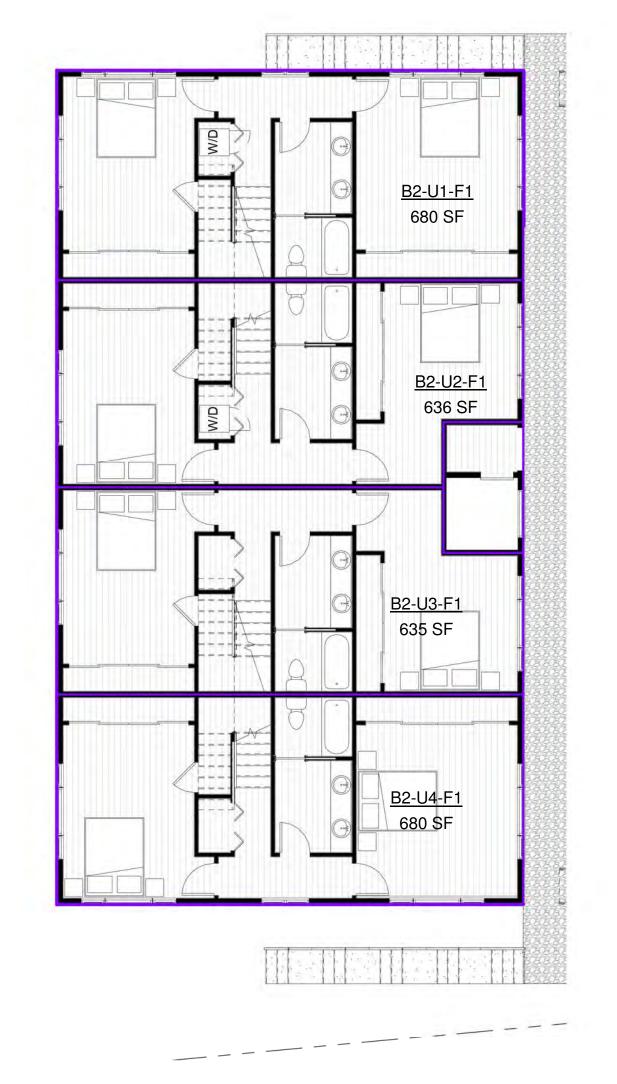



Apartments

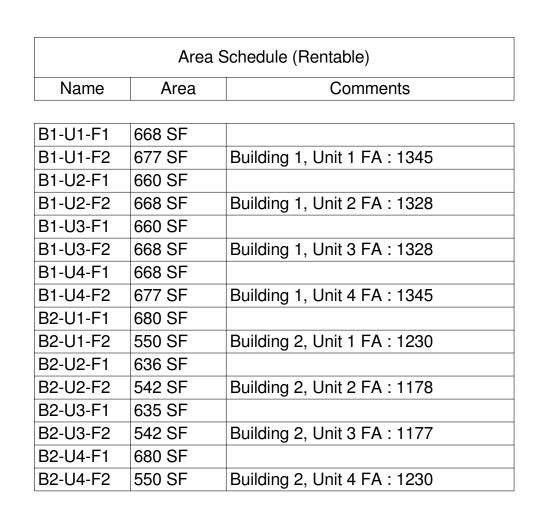Etheldore Apar Etheldore

REVISIONS

No. C23077
Ren. 1/31/21

DATE: 4/18/2023

<u>D</u>

SCALE: |/8" = |'-0"

DRAWN: ECL

JOB: ETHELDORE APTS

AIO4



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EDWARD C. LOVE, ARCHITECT


REVISIONS

vard C. Love Architect

Architec 720 MILL STREE HALF MOON BAY, CA 9

Etheldore Apartments Etheldore St Moss Beach, CA

> Elevations - Bldg 2 East ≉ West

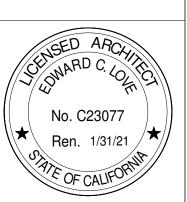


DATE: 4/18/2023

SCALE: 1/4" = 1'-0"

JOB: ETHELDORE A

SHEET: $\Delta 200$

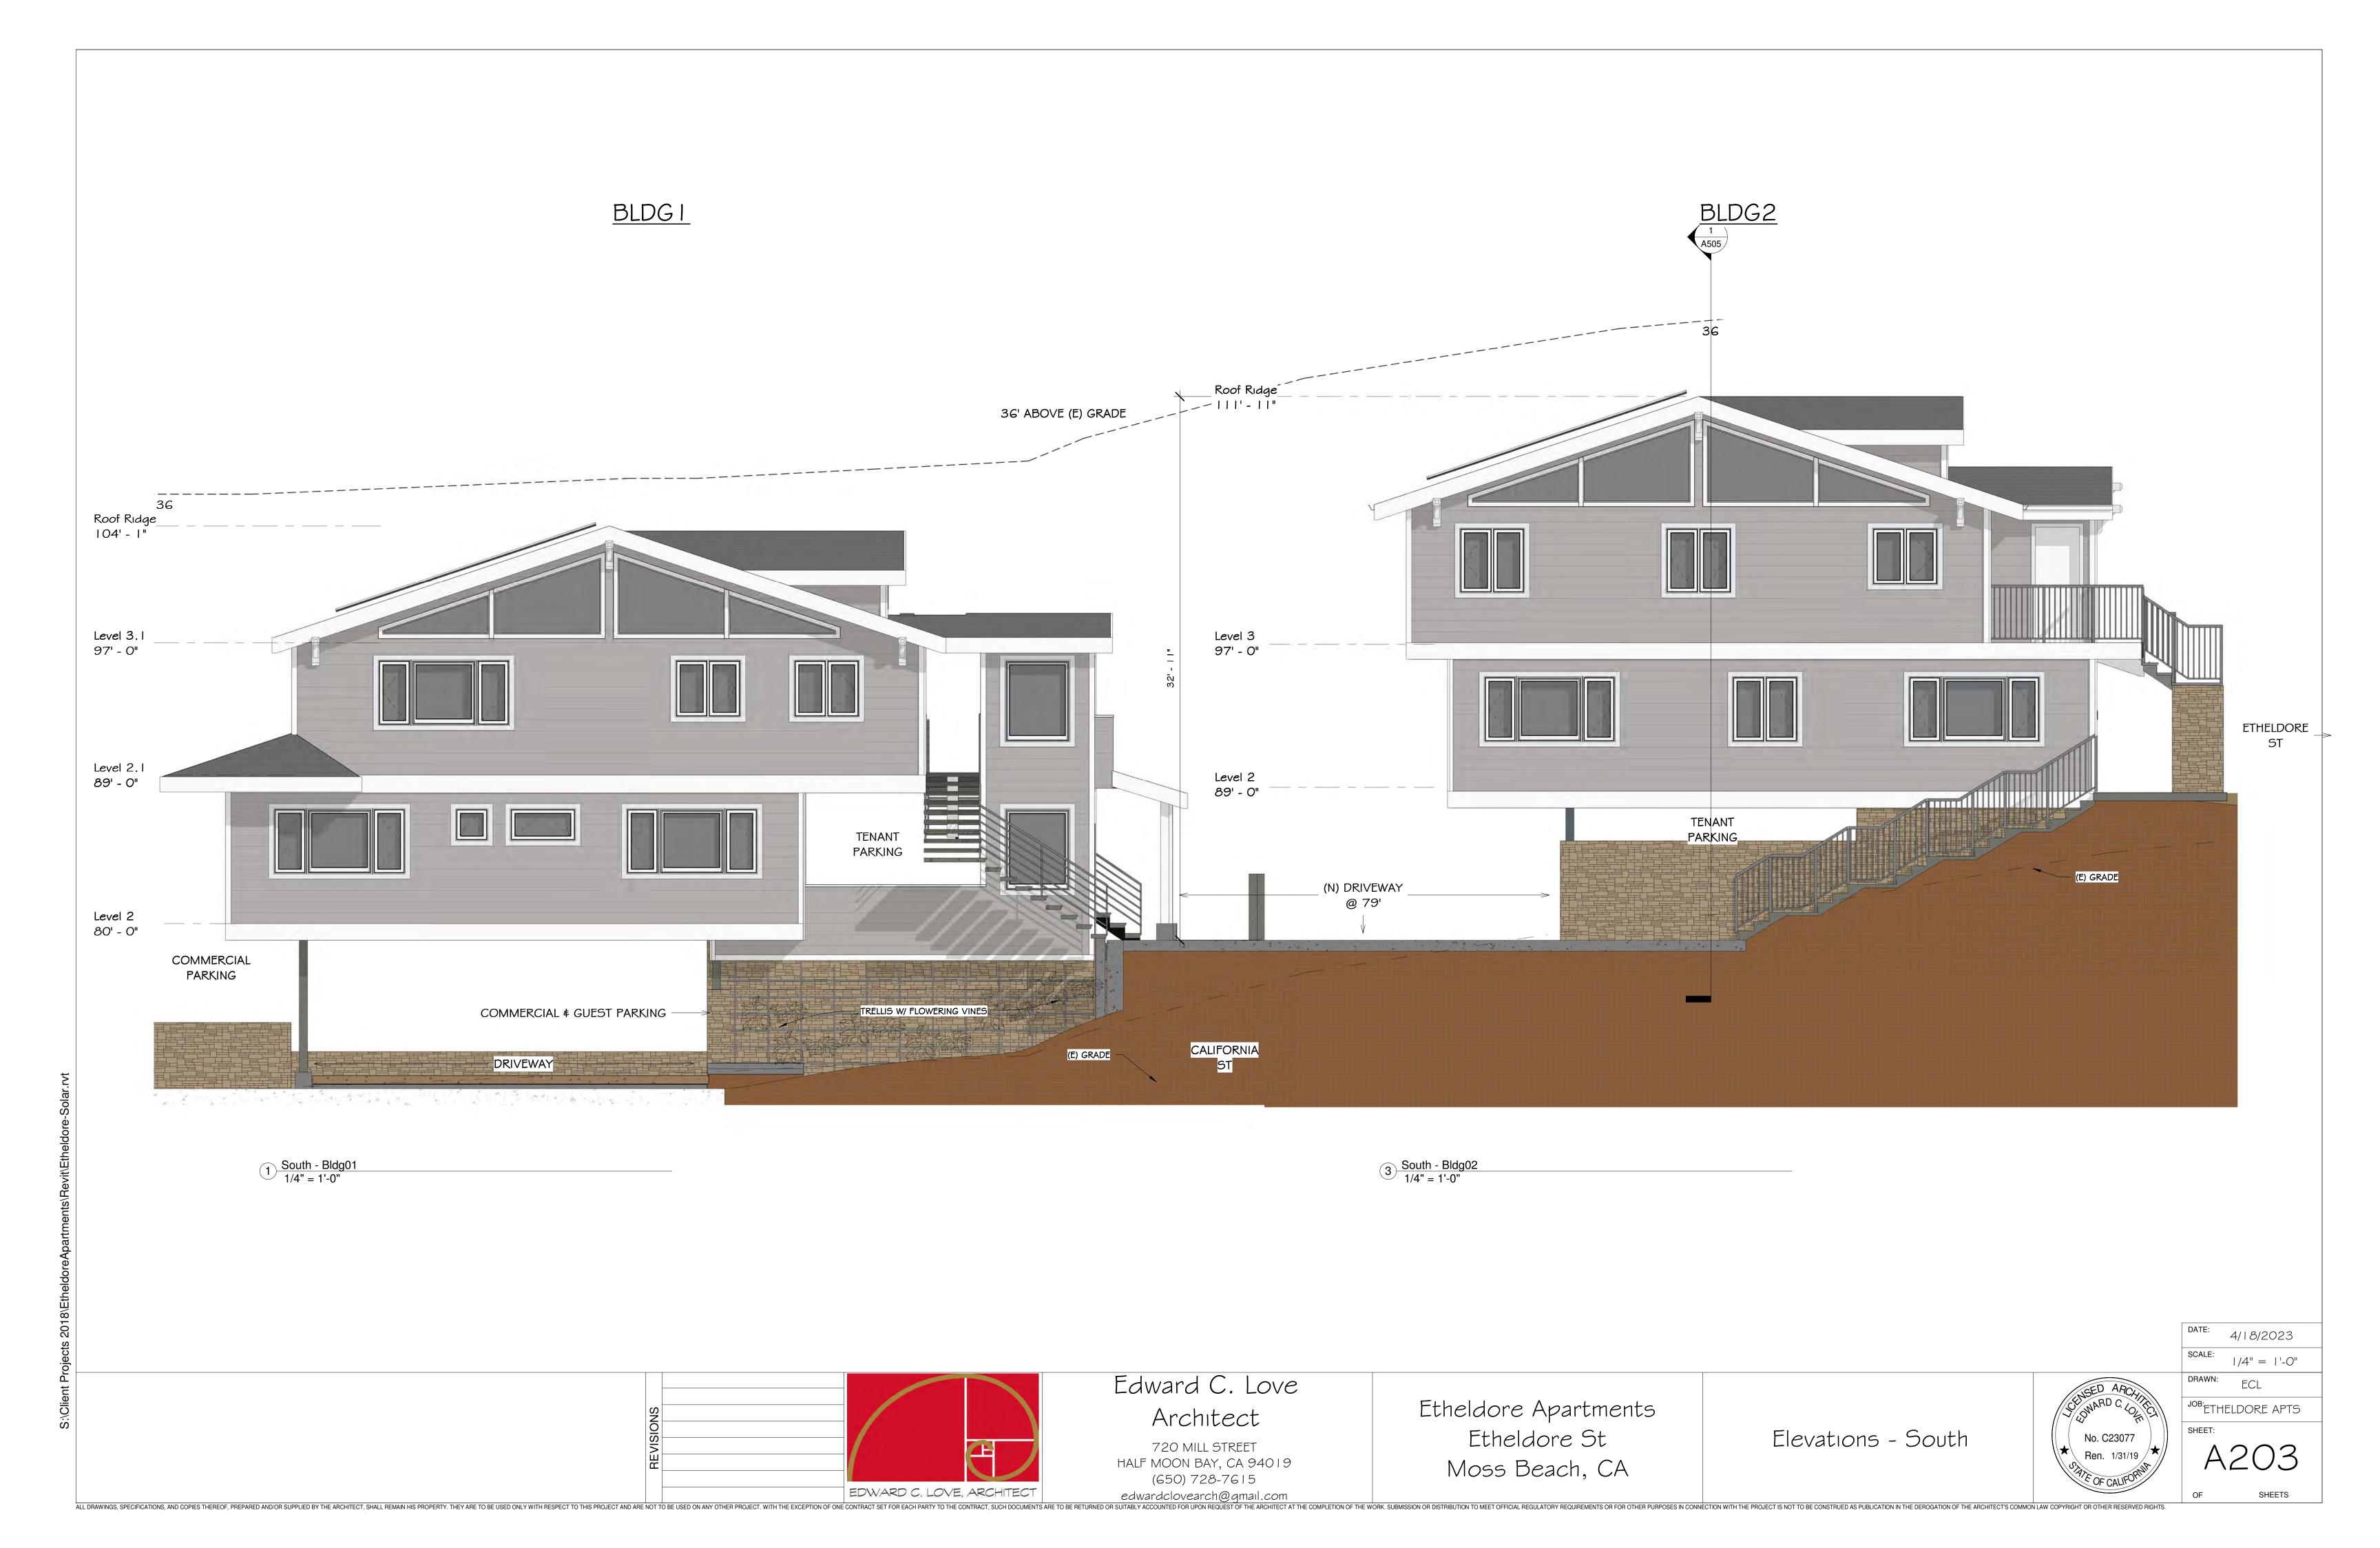

Section - Thru Site

1/8" = 1'-0"


EDWARD C. LOVE, ARCHITECT


Edward C. Love Architect


720 MILL STREET HALF MOON BAY, CA 94019 (650) 728-7615

Etheldore Apartments Etheldore St Moss Beach, CA

Elevations - South Site

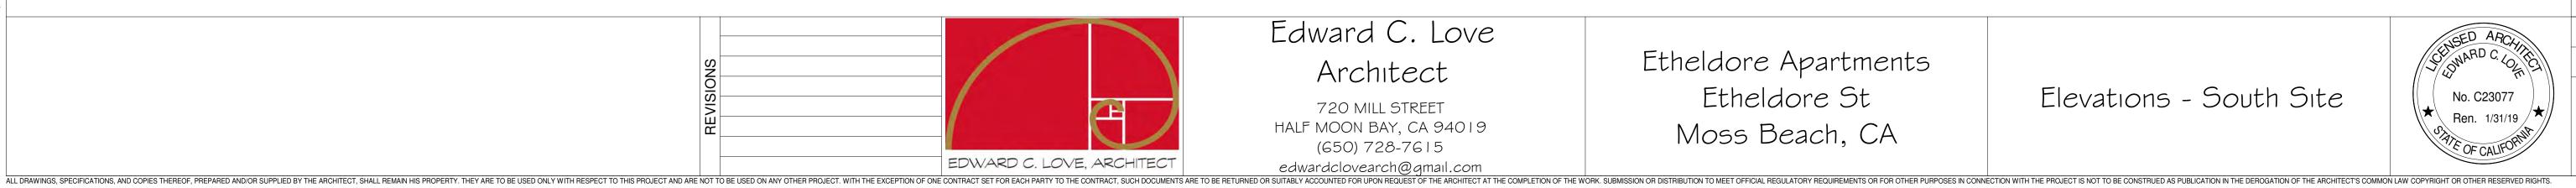

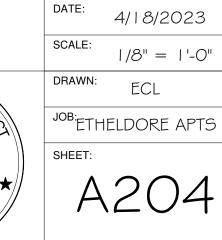

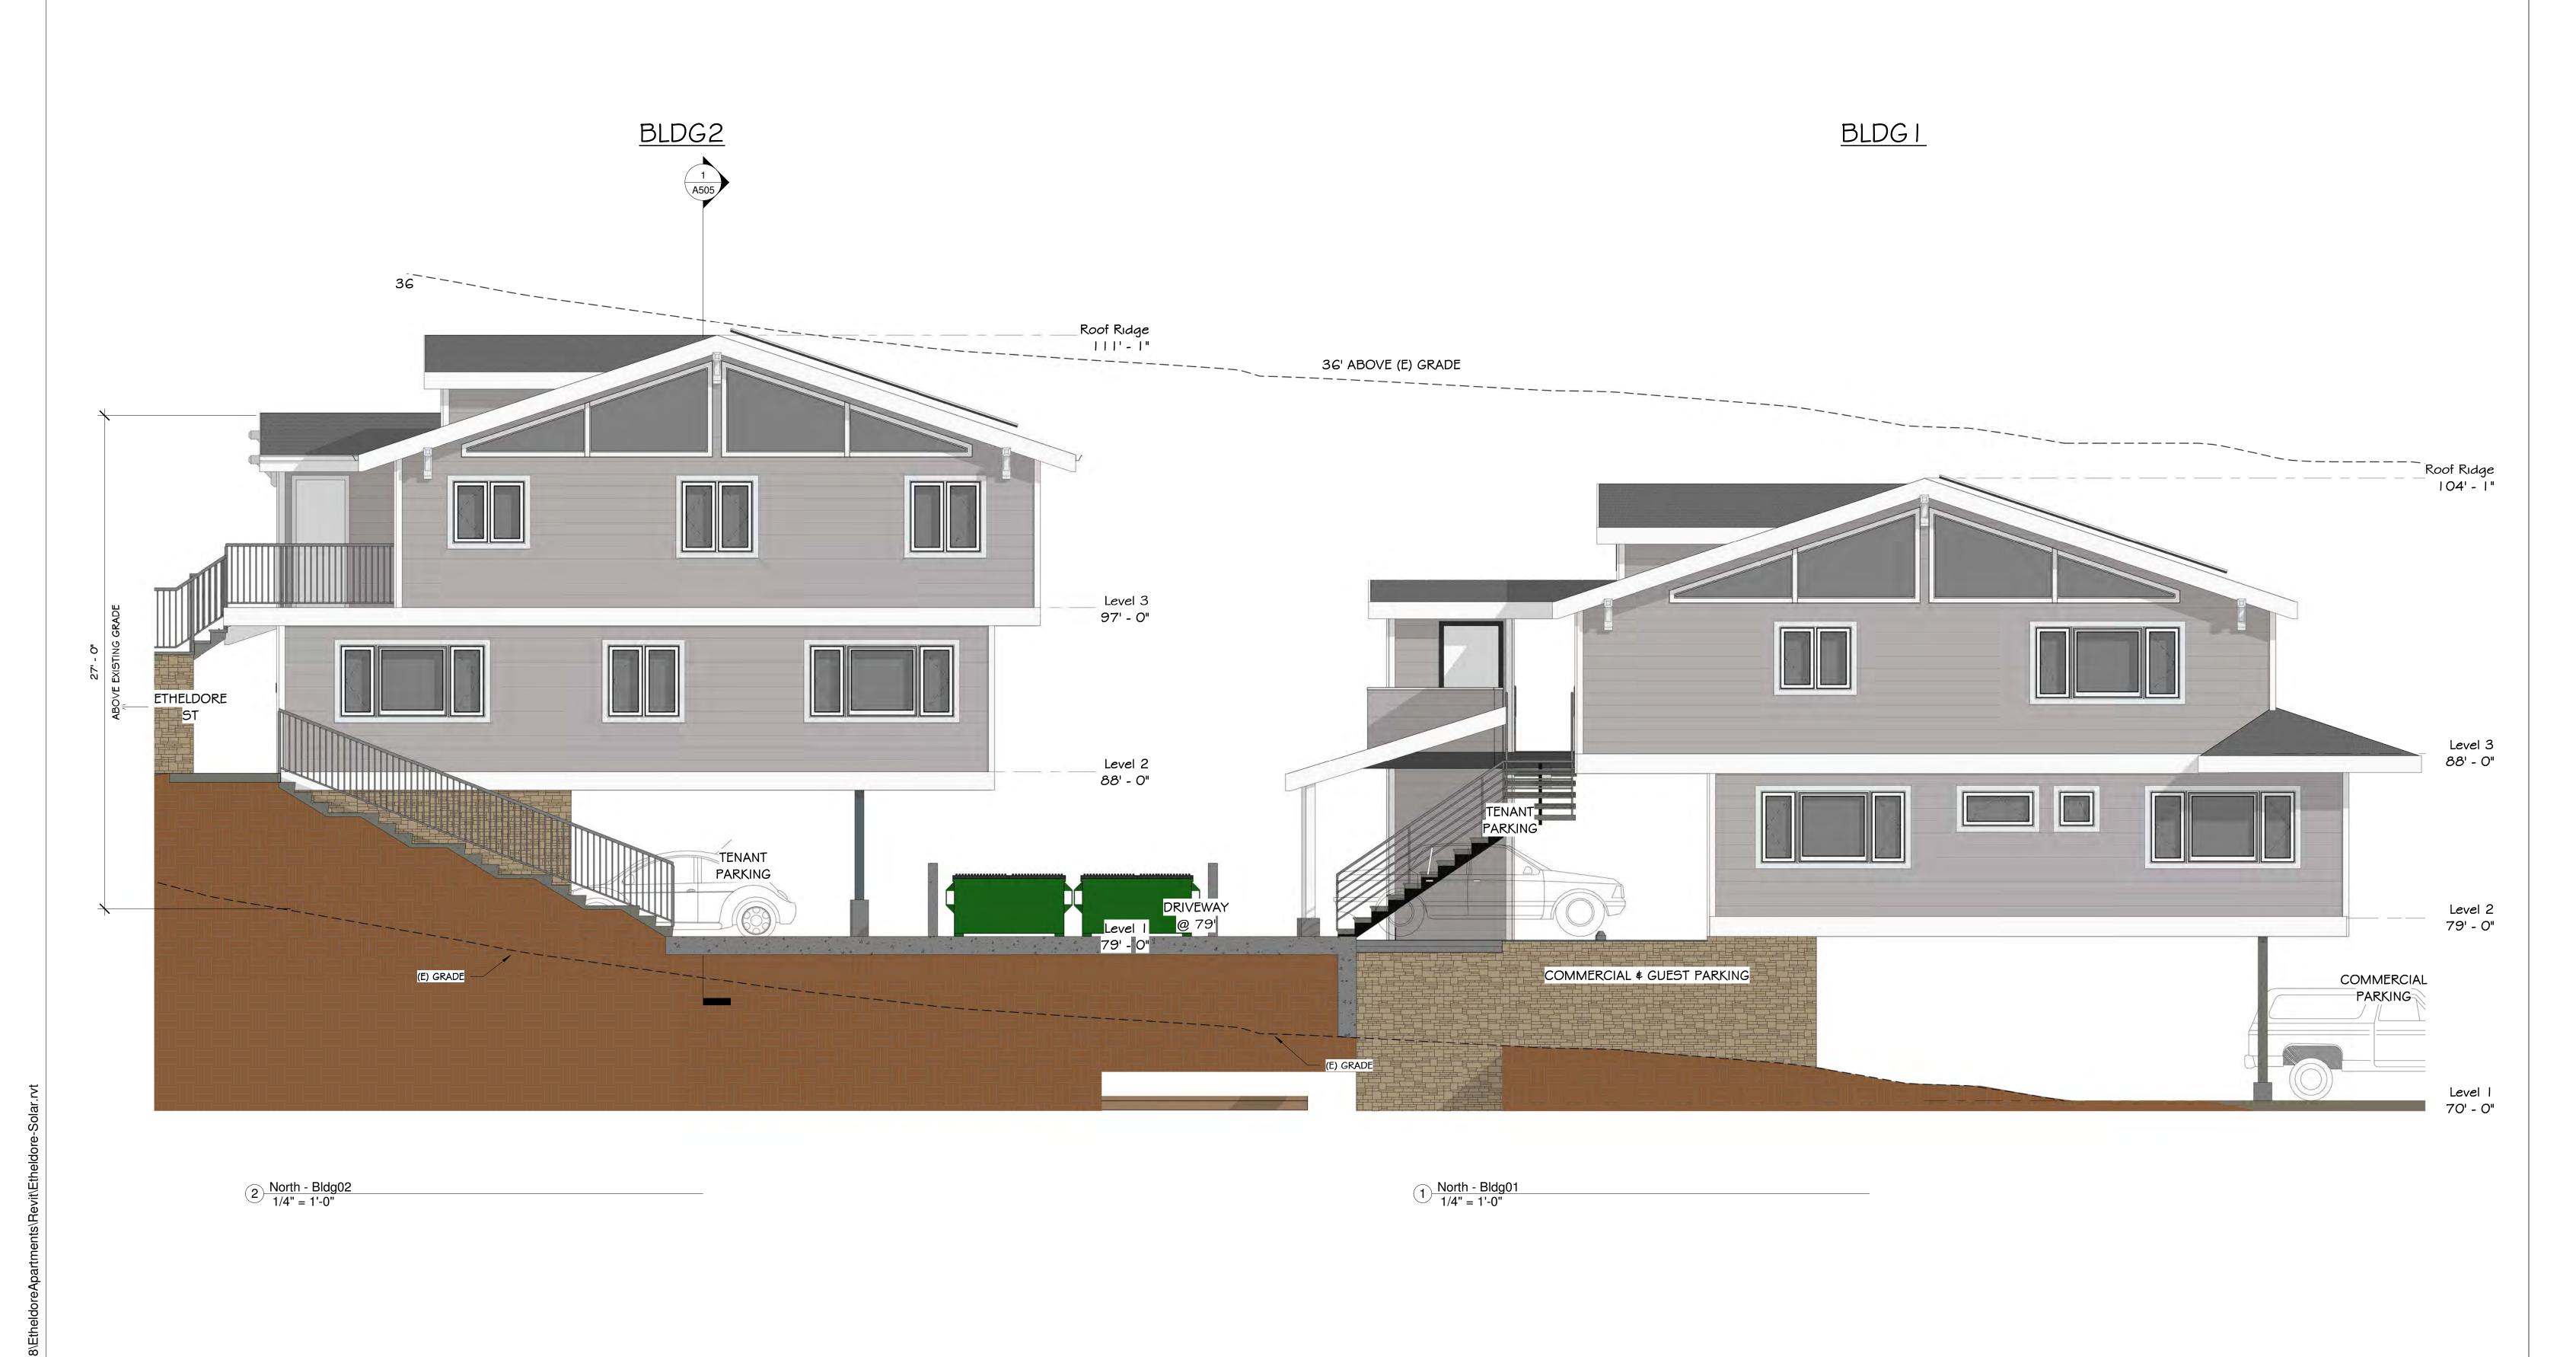


Edward C. Love Architect

720 MILL STREET HALF MOON BAY, CA 94019 (650) 728-7615

Etheldore Apartments Etheldore St Moss Beach, CA

Elevations - North

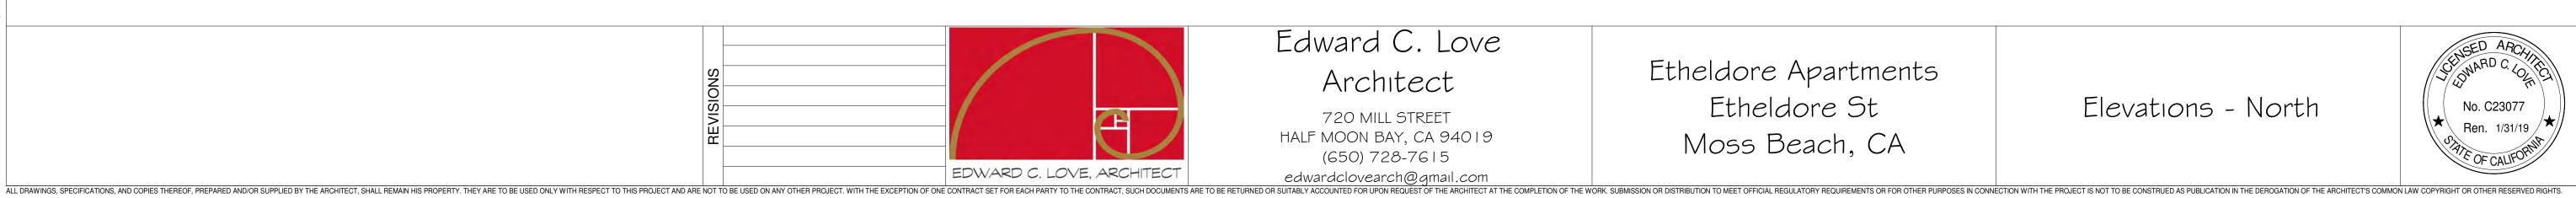

4/18/2023 DRAWN: JOB: ETHELDORE APTS



JOB:ETHELDORE AI

SHEET:
A503

SHEETS

CALIFORNA STORY

Section - Building 1 Lower Level Parking & Driveway Condition


1/4" = 1'-0"



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Section - Building 1 Upper Level Parking & Driveway Condition

1/4" = 1'-0"

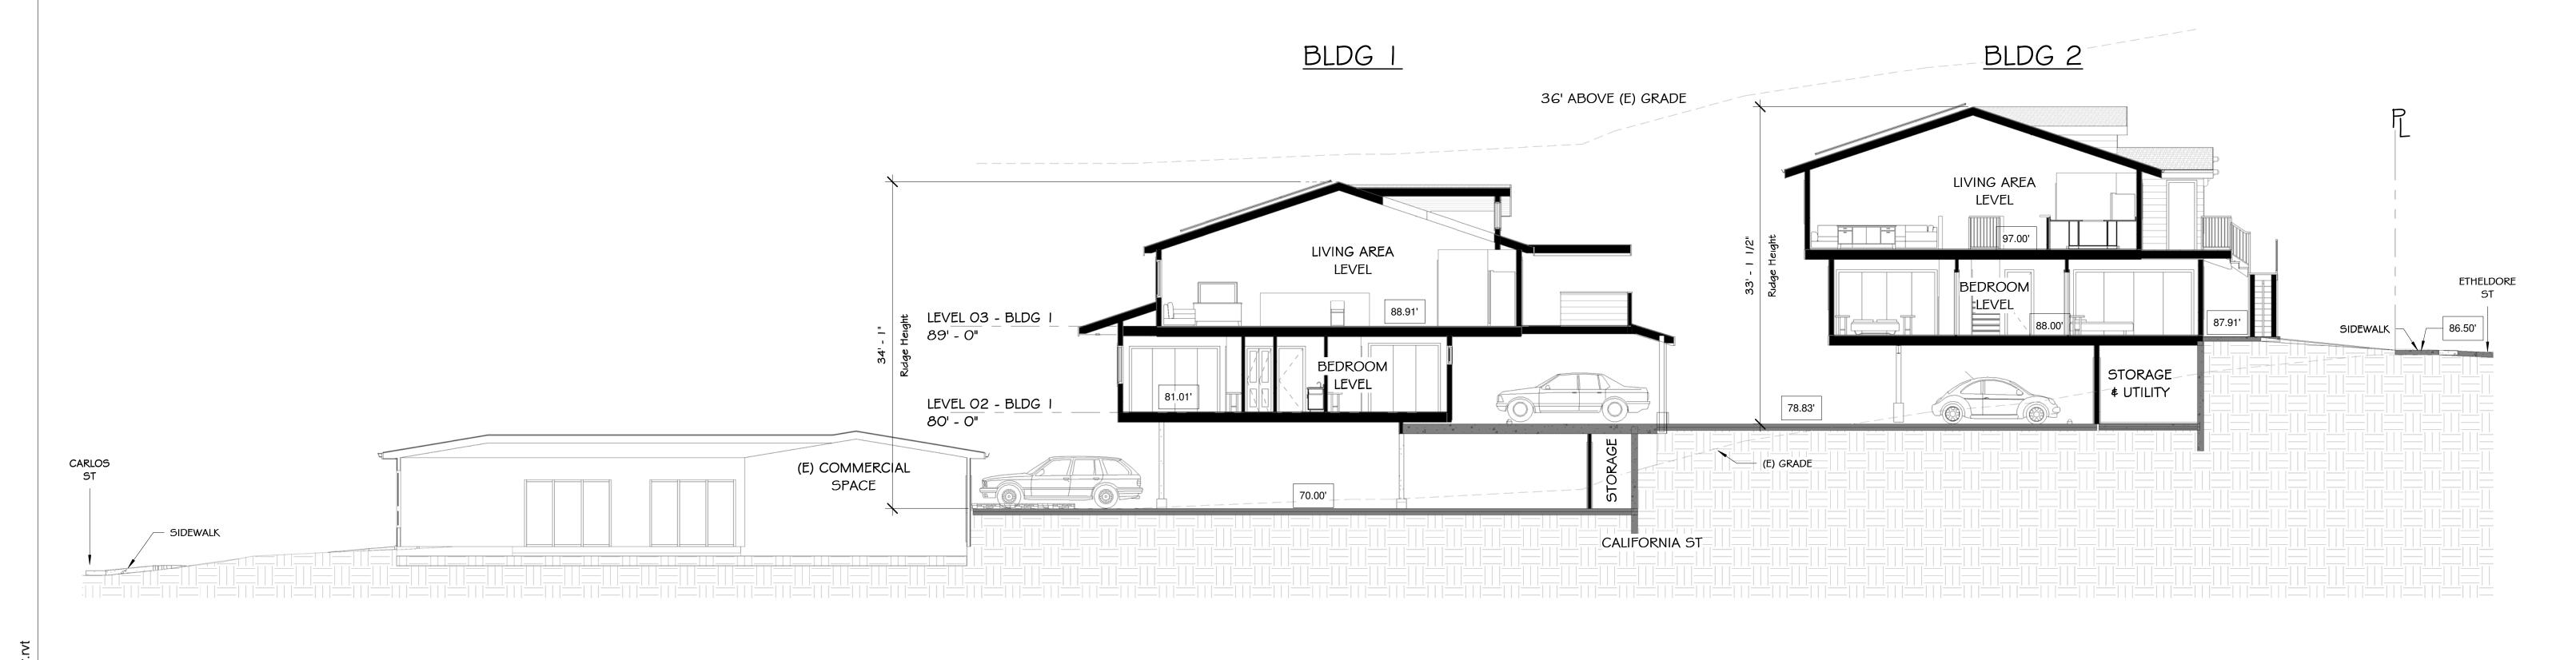

1 Section - Thru Site 1/8" = 1'-0"


EDWARD C. LOVE, ARCHITECT

Edward C. Love Architect

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Etheldore Apartments Etheldore St Moss Beach, CA

Section - Thru Site

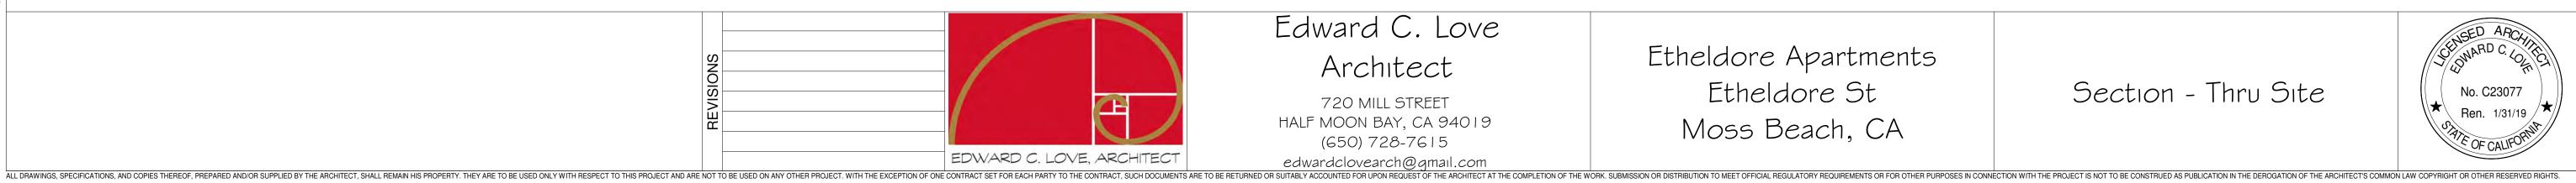

JOB:ETHELDORE APTS

4/18/2023

DRAWN:

1/8" = 1'-0"



JOB:ETHELDORE

CBO I



CERTAINEED PATRIOT SHINGLES, GRAYSTONE

HARDIE 4" TRIM - PIANTED WHITE OPULENCE OC-69

2X10 FASCIA PAINTED WHITE OPULENCE OC-69

HARDIE LAP SIDING PEARL GRAY

EL DORADO STACKED
STONE VENEER

42" HIGH WOOD RAILING



HARDIE LAP SIDING PEARL GRAY

PV PANELS

MILGARD STATLINE WHITE

HARDIE 4" TRIM -PIANTED WHITE OPULENCE OC-69

EL DORADO STACKED STONE VENEER



JAMES HARDIE

LAP SIDING

PEARL GRAY



East Elevation
1/4" = 1'-0"

DEMOSTRATION OF SCALE --CALIFORNIA STREET VIEW





NOTICE OF COASTSIDE DESIGN REVIEW

A Design Review application has been filed with the County of San Mateo Planning and Building

Department on this property:		
Address: 2385 Carlos Street, Moss Beach (APN	I: 037-097-200)	
Owner's Name: Gipson Purayampallil, Coa	stside Market Llc	
Project Description: 🔳 New	SFR Addition	Major Modification
Area (SF): (Building 1: 5,346 sq. ft.; Building 2:	4,815 sq. ft.) Height: app	proximately 36 feet
Exterior Surface/Color: Light Gray, D	ark Gray, Black trim	
Proposed trees to be removed:		
Tree Diameter (at 4 ft. height)	Species	Marking by which trees can be identified
None		

Tree Diameter (at 4 ft. height)	Species	Marking by which trees can be identified			
None					
None					

Planning Permit Number: PLN 2019-00143

Plans for this project are available for review at the County of San Mateo Planning and Building Department, 455 County Center, Redwood City, CA 94063. All comments or inquiries should be addressed to the Design Review Officer at the address above or by phoning, 650/363-1825. A decision on this proposal will be made no sooner than ten (10) days after the posting of this notice. A public hearing by the County of San Mateo Design Review Committee will be held as indicated below.

ime:	3:00 pm	
aena	da Item No: 3	

Agend	la Item No: <u>3</u>	
Hearir	ng Location:	
	Granada Community Services District 504 Avenue Alhambra, 3rd Floor, El Granada	Other

L:\GRAPHICS\Publications\Design Review\Design Review Notice - Coastside 12012015_rj.pdf

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CENSED ARC, CENNARD C. LC

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No. C23077

Ren. 1/31/21

*

DATE: 4/18/2023

SCALE: 3/32" = 1'-

JOB:ETHELDORE APTS


DoSI

SHEETS

Client Brojects 2018\Etheldere Anartments\Bevit\Etheldere Solar nr

CARLOS ST.

Section 5

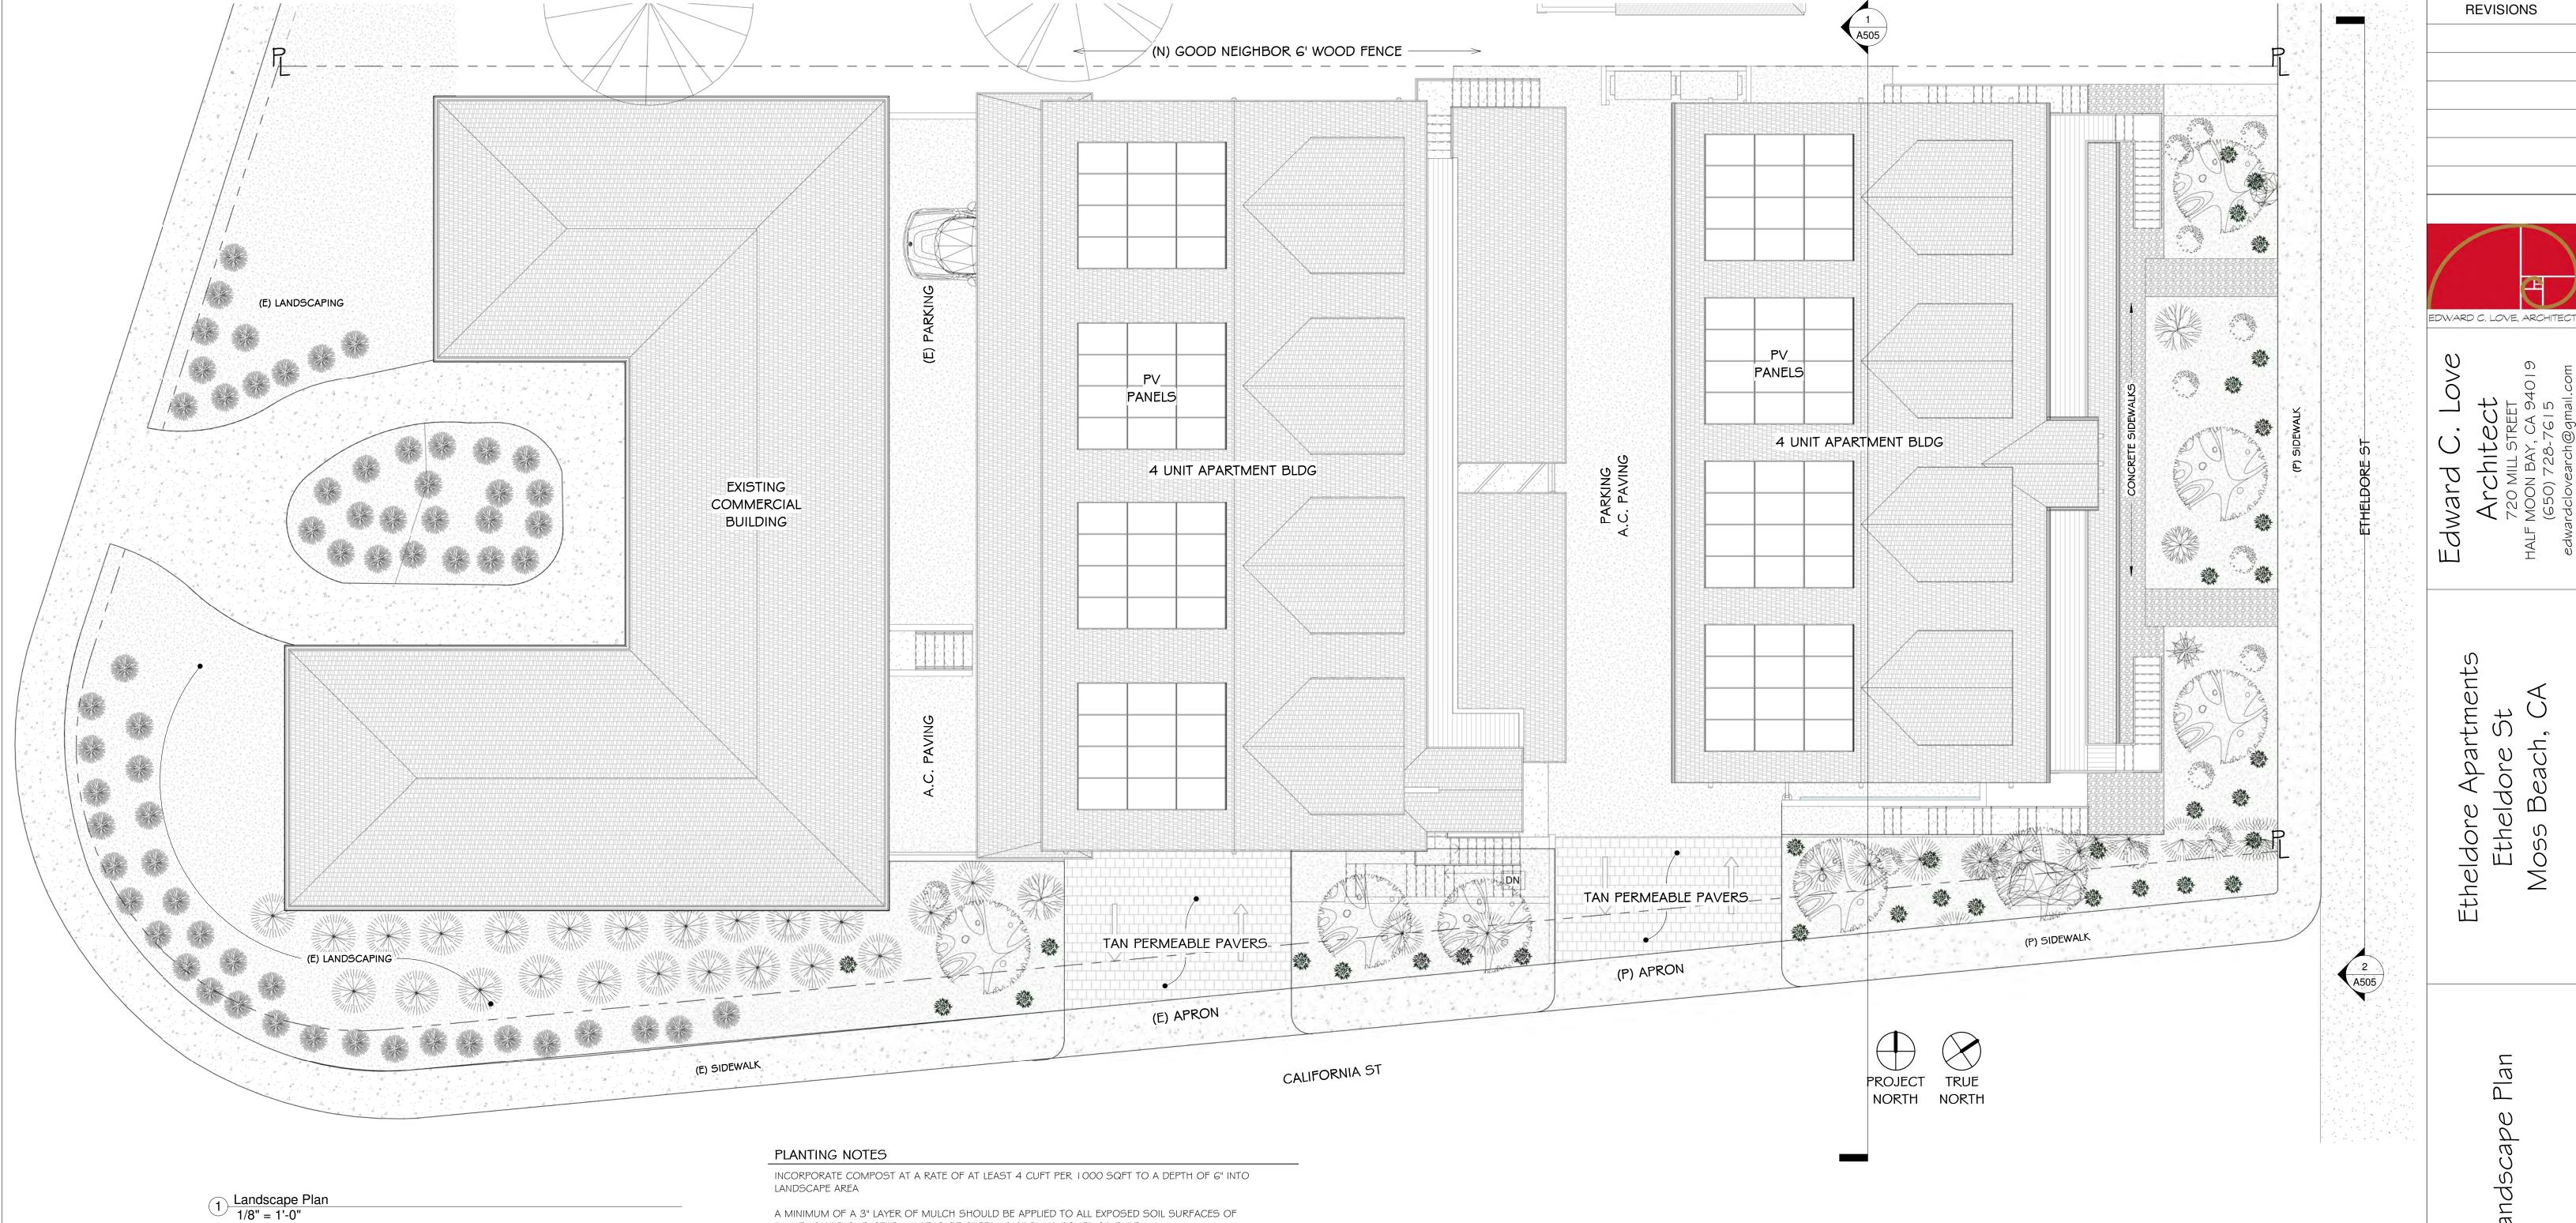

SUNSET CLIMATE ZONE: 17

PLANT LIST

	FLANT LIST				
	NAME	COMMON NAME	QTY/SIZE	WI	TYPE
	METROSIDEROS EXCELSA	NEW ZEALAND X-MAS TREE	6 - 15 GAL	L	TREE
	WESTRINGIA FRUTICOSA	COAST ROSEMARY	14 - 5 GAL	L	SHRUB
**	LEUCADENDRON SPP	CONEBUSH	2 - 5 GAL	L	SHRUB
*	MORAEA IRIDIOIDES	MORAEA	2 - I GAL	L	SHRUB
*	COPROSMA REPENS VARIGATA	VARIGATED MIRROR PLANT	2 - 5 GAL	L	SHRUB
激	CALANDRINIK SPECTABILIS	ROCK PURSLANE	37 - I GAL	L	GROUND COVER

6 - 15 GAL 18 - 5 GAL 39 - I GAL

PLANTING AREAS, EXCEPT IN AREAS OF CREEPING GROUND COVER OR TURF

THIS PROJECT INCORPORATES LANDSCAPING EQUAL TO OR LESS THAN 2500 SQFT AND WILL BE USING THIS FORM TO IDENTIFY PRESCRIPTIVE REQUIREMENTS WHICH WILL BE INCLUDED AS PART OF THE LANDSCAPE PROJECT.

TOTAL LANDSCAPE AREA : 925 SQFT SPECIAL LANDSCAPE AREA : N/A WATER TYPE : POTABLE WATER PURVEYOR : MWSD

I AGREE TO COMPLY WITH THE REQUIREMENTS

I CERTIFY THAT THE ABOVE INFORMATION IS CORRECT AND AGREE TO COMPLY WITH THE REQUIREMENTS OF THE PRESCRIPTIVE COMPLIANCE OPTION OF THE MWELO PER APPENDIX D

SIGNATURE

PRESCRIPTIVE COMPLIANCE

DATE : 06/02/21

ALL DRAWINGS, SPECIFICATIONS, AND COPIES THEREOF, PREPARED AND/OR SUPPLIED BY THE ARCHITECT, SHALL REMAIN HIS PROJECT AND ARE TO BE USED ON ANY OTHER PROJECT AND ARE NOT TO BE USED ON ANY OTHER PROJECT. WITH THE EXCEPTION OF ONE CONSTRUED AS PUBLICATION IN THE DEROGATION OF THE ARCHITECT, SHALL REMAIN HIS PROJECT AND ARE NOT TO BE USED ON ANY OTHER PROJECT AND ARE NOT TO BE USED ON ANY OTHER PROJECT. WITH THE EXCEPTION OF THE ARCHITECT, SHALL REMAIN HIS PROJECT AND ARE NOT TO BE USED ON ANY OTHER PROJECT. WITH THE EXCEPTION OF THE ARCHITECT, SHALL REMAIN HIS PROJECT AND ARE NOT TO BE USED ON ANY OTHER PROJECT. WITH THE EXCEPTION OF THE ARCHITECT, SHALL REMAIN HIS PROJECT AND ARE NOT TO BE USED ON ANY OTHER PROJECT. WITH THE EXCEPTION OF THE ARCHITECT, SHALL REMAIN HIS PROJECT AND ARE NOT TO BE USED ON ANY OTHER PROJECT. WITH THE EXCEPTION OF THE ARCHITECT, SHALL REMAIN HIS PROJECT AND ARE NOT TO BE USED ON ANY OTHER PROJECT. WITH THE EXCEPTION OF THE ARCHITECT, SHALL REMAIN HIS PROJECT AND ARE NOT TO BE USED ON ANY OTHER PROJECT. WITH THE EXCEPTION OF THE ARCHITECT, SHALL REMAIN HIS PROJECT AND ARE NOT TO BE USED ON ANY OTHER PROJECT. WITH THE EXCEPTION OF THE ARCHITECT, SHALL REMAIN HIS PROJECT AND ARE NOT TO BE USED ON ANY OTHER PROJECT. WITH THE EXCEPTION OF THE ARCHITECT, SHALL REMAIN HIS PROJECT AND ARE NOT TO BE USED ON ANY OTHER PROJECT. WITH THE EXCEPTION OF THE ARCHITECT, SHALL REMAIN HIS PROJECT AND ARE NOT TO BE USED ON ANY OTHER PROJECT. WITH THE EXCEPTION OF THE ARCHITECT, SHALL REMAIN HIS PROJECT AND ARCHITECT.

ALL PLANTINGS TO BE HAND WATERED MODEL WATER EFFICIENT LANDSCAPE ORDINANCE (MWELO) SHORT FORM

MWELO APPLICANT: JERRY ALAN WHITING FLORA FARM 340 PURISSIMA ST HALF MOON BAY, CA 94019 LIC #549103

650.678.5801

4/18/2023 As indicated

DRAWN: ECL JOB: ETHELDORE APTS